

PROJECT TEAM: OWNER: DAVID & KAREN ODMARK

T: 858.945.5430 E: dave.odmark@cushwake.com

ARCHITECT:

HLLK ARCHITECTS 5727 LA JOLLA BLVD LA JOLLA, CA 92037 T: 858.255.1561 hilary@HLLKarchitects.com

STRUCTURAL:

CURTIS PATTERSON PATTERSON ENGINEERING 928 FORT STOCKTON DRIVE, SUITE 201 SAN DIEGO, CA 92103 T: 858.605.0937

curtis@pattersoneng.com

SHEET LIST:

A000 TITLE SHEET A001 TOPOGRAPHIC SURVEY A002 GENERAL NOTES A006 STORMWATER CONCEPT A007 EXTERIOR LIGHTING PLAN A100 SITE PLAN A200 FIRST FLOOR DEMO PLAN A300 PROPOSED LOWER LEVEL PLAN

A400 PROPOSED FIRST FLOOR PLAN

A401 FIRST FLOOR DIMENSIONS A500 ROOF PLAN A600 ELEVATIONS

A601 ELEVATIONS A900 SITE PHOTOS

GENERAL NOTES: IT IS NOT THE INTENT OF THESE DRAWINGS TO SHOW EVERY DETAIL OF CONSTRUCTION. IT SHALL BE THE BUILDERS RESPONSIBILITY TO CHECK, VERIFY, AND COORDINATE ALL DIMENSIONS, DETAILS, NOTES, AND ALL PHASES AND THE TRADES REQUIRED TO COMPLETE THIS PROJECT. ALL FINISH, FIXTURE, AND EQUIPMENT SELECTIONS SHALL BE VERIFIED WITH THE OWNER OR HIS AUTHORIZED AGENT.

2. ALL WORK IS TO BE PERFORMED IN A FIRST-CLASS WORKMANSHIP LIKE MANNER.

FIGURED DIMENSIONS SHALL BE FOLLOWED IN PREFERENCE TO SCALE, AND DETAIL DRAWINGS IN PREFERENCE TO SMALL SCALE DRAWINGS. FIELD VERIFY ALL DIMENSIONS PRIOR TO FABRICATION OR ERECTION OF ANY PORTION OF THIS PROJECT.

4. IF ANY ERRORS, OMISSIONS, OR CONTRADICTIONS APPEAR IN THESE CONSTRUCTION WORKING DRAWINGS, SPECIFICATIONS OR OTHER CONSTRUCTION DOCUMENTS: THE CONTRACTOR SHALL NOTIFY THE ARCHITECT IN WRITING. NO WORK SHALL CONTINUE UNTIL SUCH TIME AS THE ERROR, OMISSION, OR CONTRADICTION HAS BEEN RESOLVED. GIVING SAID NOTICE TO THE ARCHITECT DOES NOT RELIEVE THE CONTRACTOR OF HIS RESPONSIBILITY TO CHECK, VERIFY, AND COORDINATE THE DIMENSIONS OR ANY OTHER PORTION OF THE CONSTRUCTION DOCUMENTS, OR FOR THE COST OF THE SAME.

5. CONSTRUCTION OF THIS BUILDING MUST COMPLY WITH ALL THE REQUIREMENTS AND CONSTRUCTION PRACTICES AS SET FORTH IN THE "CALIFORNIA ENERGY EFFICIENCY CODE FOR BUILDING CONSTRUCTION", LATEST EDITION.

CONTRACTORS ARE INSTRUCTED TO ADJUST, VERIFY, AND COORDINATE AND INFORMATION NOTED HEREIN AS "TYPICAL".

ALL CONSTRUCTION SHALL BE PERFORMED IN ACCORDANCE WITH ALL CODES, REGULATIONS AND RESTRICTIONS HAVING JURISDICTION OVER THIS PROJECT. THE BUILDER SHALL BE RESPONSIBLE FOR BEING FAMILIAR WITH THE APPLICABLE CODES, REGULATIONS, AND RESTRICTIONS AND THEIR RELEVANCE TO THE PROJECT.

GYPSUM WALLBOARD SHALL COMPLY WITH THE PROVISIONS OF THE "SPECIFICATIONS FOR GYPSUM WALLBOARD", ASTM #C-36. GYPSUM WALLBOARD SHALL BE INSTALLED AND FINISHED IN ACCORDANCE WITH THE PROVISIONS OF THE "RECOMMENDED SPECIFICATIONS FOR THE APPLICATION AND FINISHING OF GYPSUM WALLBOARD", GYPSUM ASSOCIATION SPECIFICATION #GA-216.

ODMARK RESIDENCE ADDITION & RENOVATION

143 E. LAKE STREET MCCALL, IDAHO 83638

SCOPE OF WORK:

OCCUPANCY:

THIS PROJECT PROPOSES A 704 SF ADDITION AND 169 SF REMODEL ON THE MAIN LEVEL AND A 688 ADDITION TO THE LOWER LEVEL. ALSO CASEWORK

ADDITIONS TO (E) KITCHEN ON MAIN LEVEL.

APPLICATION: BUILDING PERMIT

PROJECT INFORMATION:

RPM00000095540

LEGAL DESCRIPTION: MCCALL ACREAGE, TAX NO. 159-A IN GOV'T. LOT 4, S9 T18N R3E

539800 MCCALL RES. BY LAND GRADE

541 RES IMPR ON CAT 20

(R4) - LOW DENSITY RESIDENTIAL: MAXIMUM DENSITY OF FOUR (4) DWELLING UNITS ZONE:

PER ACRE

SINGLE FAMILY RESIDENTIAL

OVERLAYS: SHORELINE AND RIVER ENVIRONS ZONE

YEAR OF ORIGINAL CONSTRUCTION: 2009

SINGLE FAMILY RESIDENTIAL

CONSTRUCTION TYPE: V-A N/A FIRE SPRINKLERS: 13,182 SF LOT AREA: ALLOWABLE HEIGHT: PROPOSED HEIGHT: 21' 11 1/4"

ALLOWABLE SETBACKS:

FRONT: **REAR**: SIDE:

63.04' x .08 = 5.04' x 2 = 10.09' TOTAL SIDE:

EXISTING BUILDING SQUARE FOOTAGE: LOWER LEVEL: FIRST FLOOR: 1,980 SF **UPPER FLOOR:** 1,122 SF **GARAGE**: 5,265 SF TOTAL:

PROPOSED BUILDING SQUARE FOOTAGE:

(E) LOWER FLOOR: 1,503 SF (N) LOWER FLOOR: (E) FIRST FLOOR: 1,980 SF (N) FIRST FLOOR: 704 SF (E) UPPER FLOOR: <u>1,122 SF</u> TOTAL HABITABLE: 5,997 SF (E) GARAGE: TOTAL: 6,658 SF

LOT COVERAGE: **EXISTING:**

HOUSE: 1477 SF @ 100% 1,477 GARAGE: 660 SF @ 100% = 660 SF DECK: 1050 SF @ 50% = 525 SF DRIVE: 1,600 SF @ 35% = 560 SF

EXISTING LOT COVERAGE =3,222 SF / 13,182 SF = 25%

DEMO:

HOUSE: 0 GARAGE: 0 DECK: -158 SF @ 50% = -79 SF DRIVE: -400 SF @35% = -140 SF

PROPOSED: HOUSE: 704 @100% = 688 SF GARAGE: 0

DECK: 0 DRIVE: 0

TOTAL ALLOWABLE LOT COVERAGE = 13,182 x .28 = 3,691 SF PROPOSED LOT COVERAGE = 3,691 SF / 13,182 SF = 28%

APPLICABLE CODES:

2018 INTERNATIONAL BUILDING CODE, 2020 INTERNATIONAL RESIDENTIAL CODE, 2020 INTERNATIONAL ENERGY CONSERVATION CODE, 2018 INTERNATIONAL MECHANICAL CODE, 2017 NATIONAL ELECTRICAL CODE, 2017 IDAHO STATE PLUMBING CODE, 2018 INTERNATIONAL FUEL GAS CODE, 2018 INTERNATIONAL FIRE CODE.

RELATED APPROVALS;

NONE



5727 La Jolla Blvd La Jolla, California, 92037 858.255.1561 lindsay@HLLKarchitects.com hilary@HLLKarchitects.com



$\omega \geq$

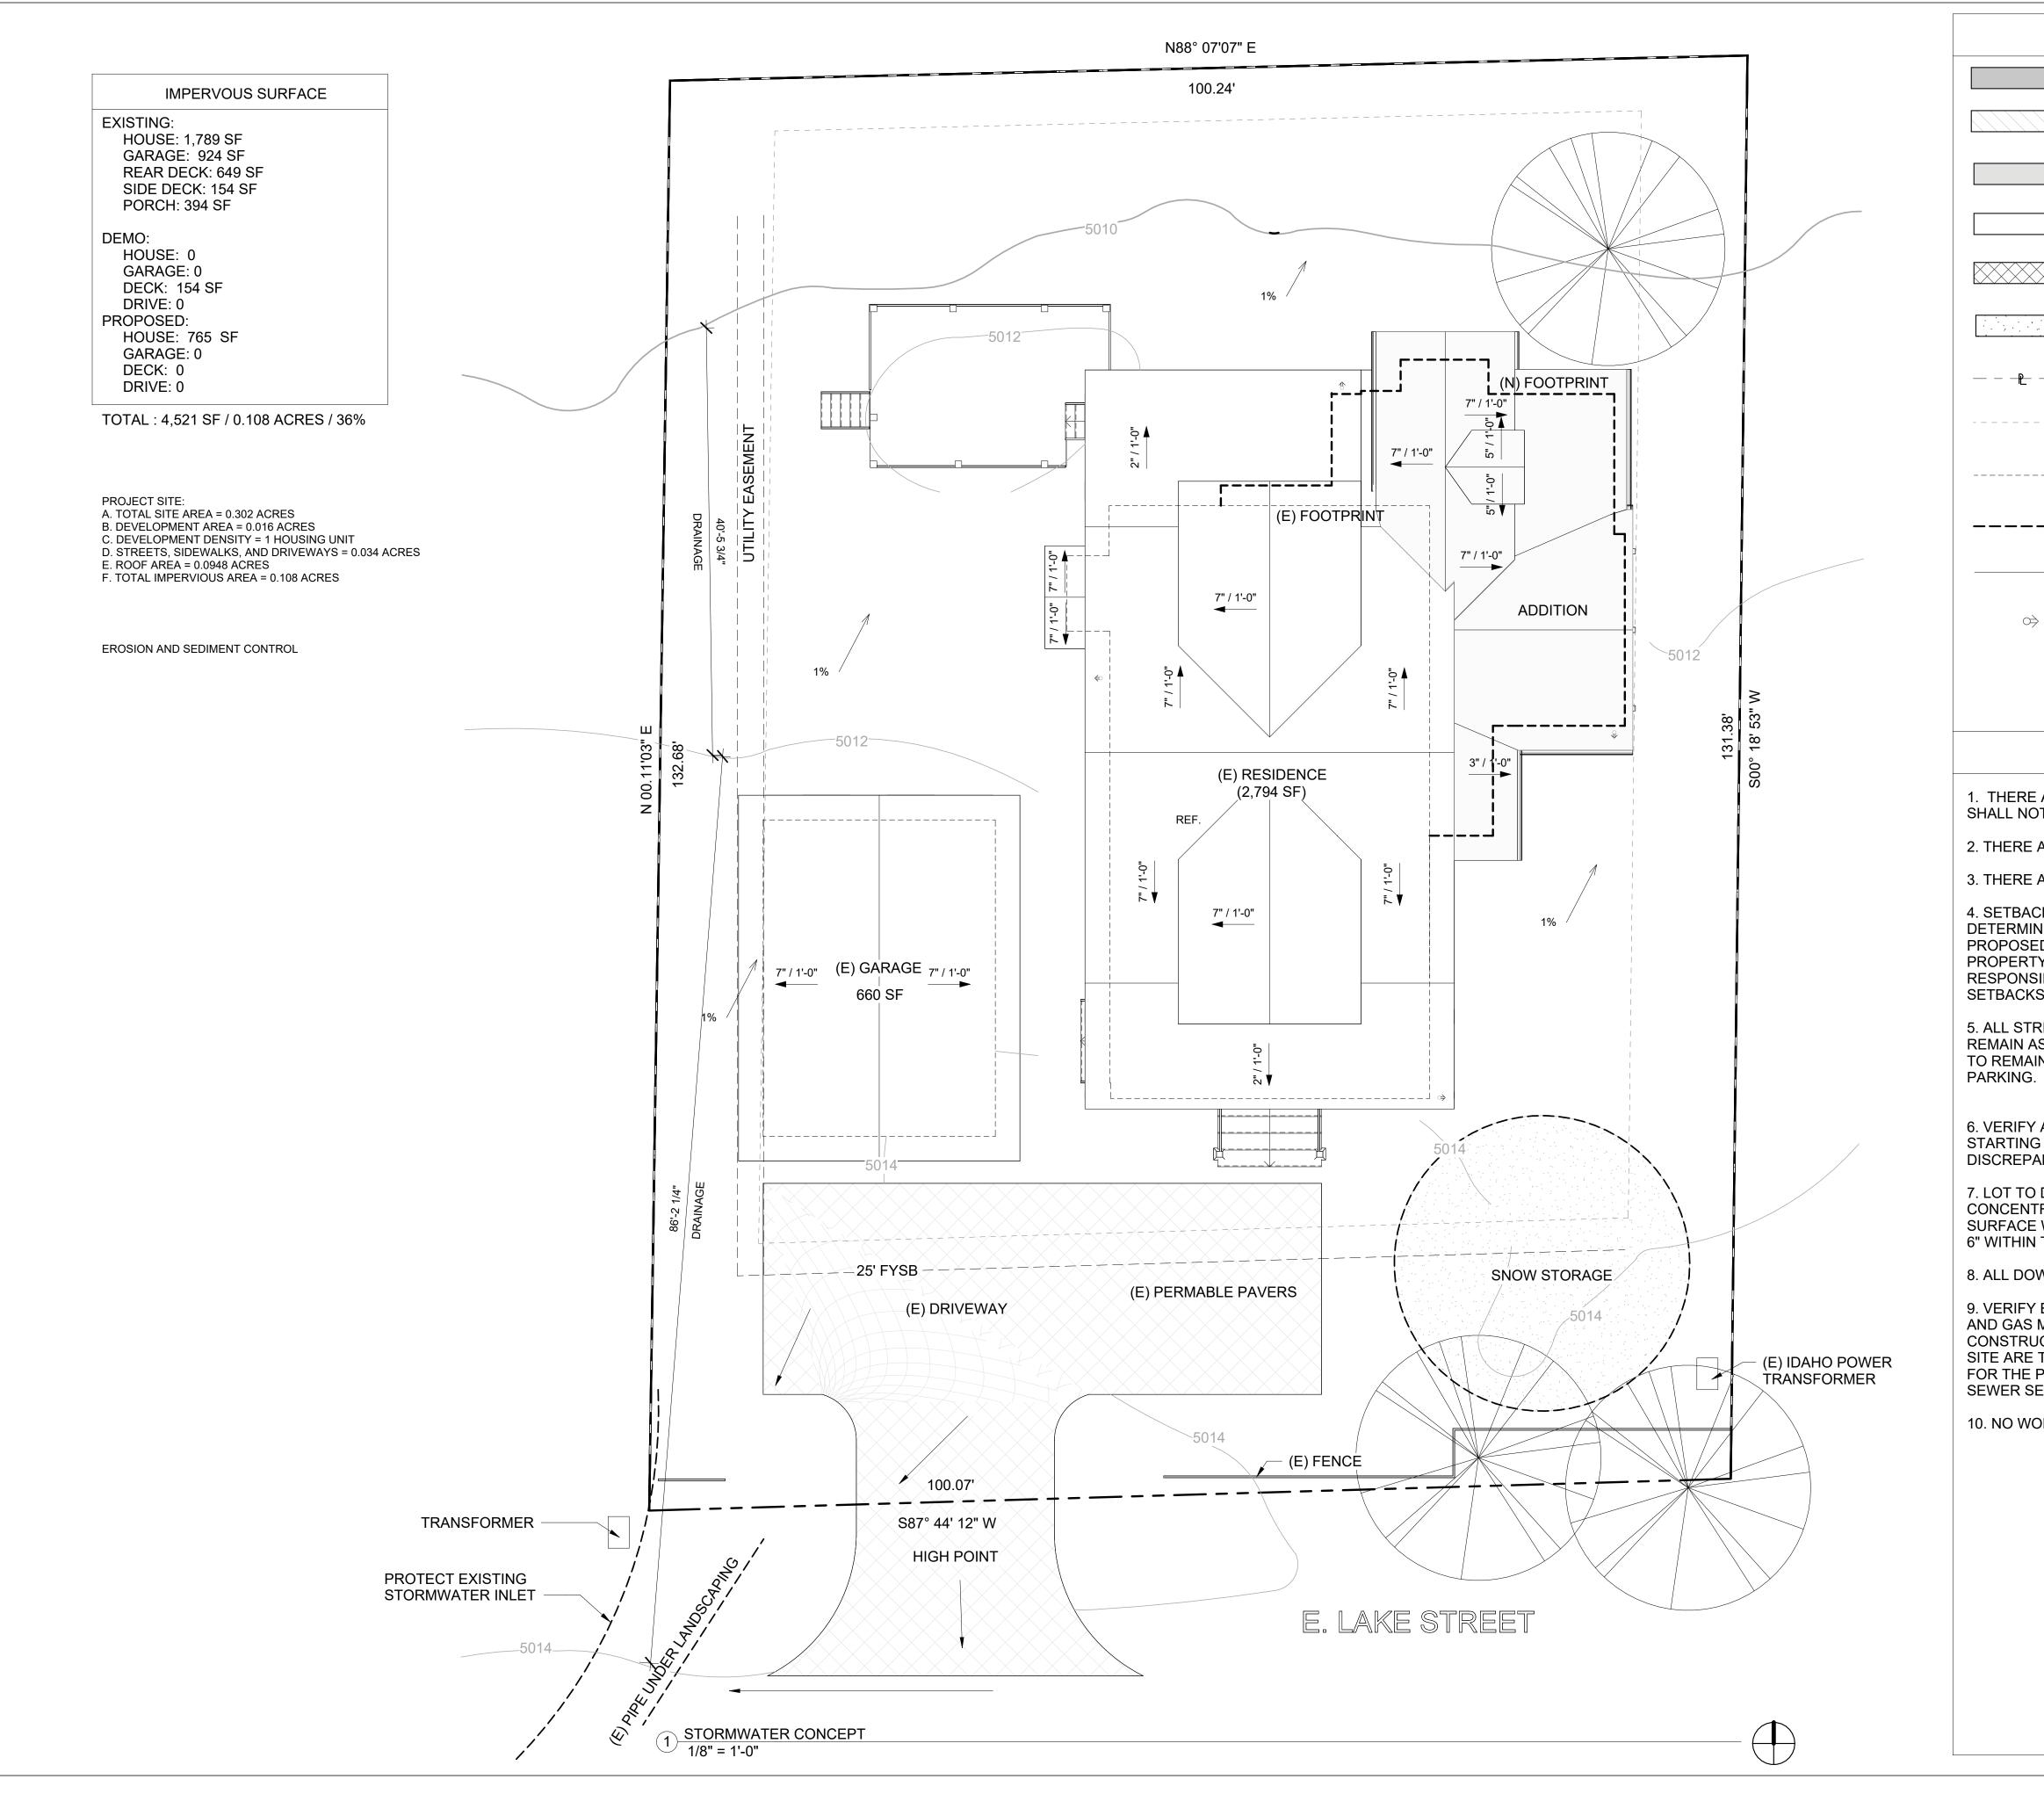
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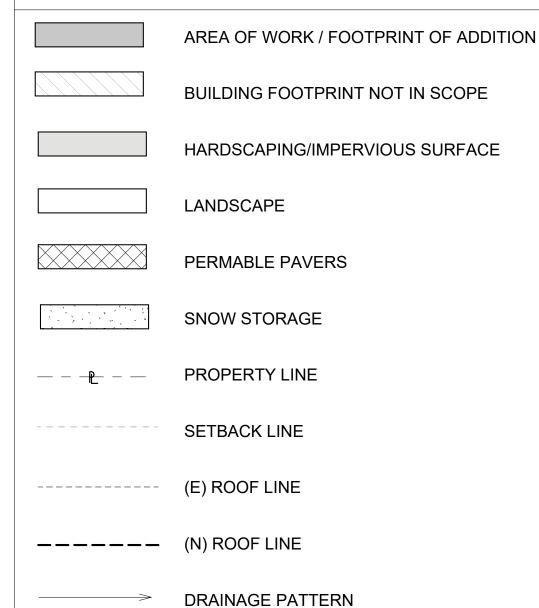
TITLE SHEET

Scale:

1'' = 1'-0''







NOTES

DOWNSPOUT

- 1. THERE ARE NO SITE WALLS OR FENCES PROPOSED AND SHALL NOT BE INCLUDED IN THIS PERMIT.
- 2. THERE ARE NO NEW SITE RETAINING WALLS PROPOSED.
- 3. THERE ARE NO EXISTING OR PROPOSED TRANSIT STOPS.

4. SETBACKS AT EXISTING BUILDING LOCATION ARE AS DETERMINED BY SURVEY & UNVERIFIED. SETBACKS AT PROPOSED CONSTRUCTION ARE MINIMUM DISTANCE TO PROPERTY LINE. IT SHALL BE THE CONTRACTOR'S RESPONSIBILITY TO ADHERE TO THOSE MINIMUM SETBACKS.

5. ALL STREET IMPROVEMENTS ARE EXISTING AND TO REMAIN AS IS. EXISTING CURB CUT AND CONCRETE APRON TO REMAIN TO SERVICE FOR EXISTING OFF-STREET

6. VERIFY ALL GRADES AND CONDITIONS IN FIELD PRIOR TO STARTING WORK. NOTIFY OWNER AND ARCHITECT OF ANY DISCREPANCIES.

7. LOT TO DRAIN TO APPROVED DRAINAGE FACILITY. NO CONCENTRATED DRAINAGE FLOW ACROSS PROPERTY LINE. SURFACE WATER SHALL DRAIN AWAY FROM THE BUILDING - 6" WITHIN THE FIRST 10 FEET.

8. ALL DOWNSPOUTS SHALL DRAIN TO LANDSCAPE AREAS.

9. VERIFY EXISTING UTILITY LOCATIONS AND NEW ELECTRIC AND GAS METER LOCATIONS BEFORE START OF CONSTRUCTION. ALL OVERHEAD UTILITIES SERVING THE SITE ARE TO BE VERIFIED AND ADJUSTED AS NECESSARY FOR THE PROPOSED ADDITION. THE EXISTING WATER AND SEWER SERVICES WILL REMAIN.

10. NO WORK SHALL BE PERFORMED IN UTILITY EASEMENT.



5727 La Jolla Blvd La Jolla, California, 92037 858.255.1561 lindsay@HLLKarchitects.com hilary@HLLKarchitects.com



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Drawing Title:

STORMWATER CONCEPT

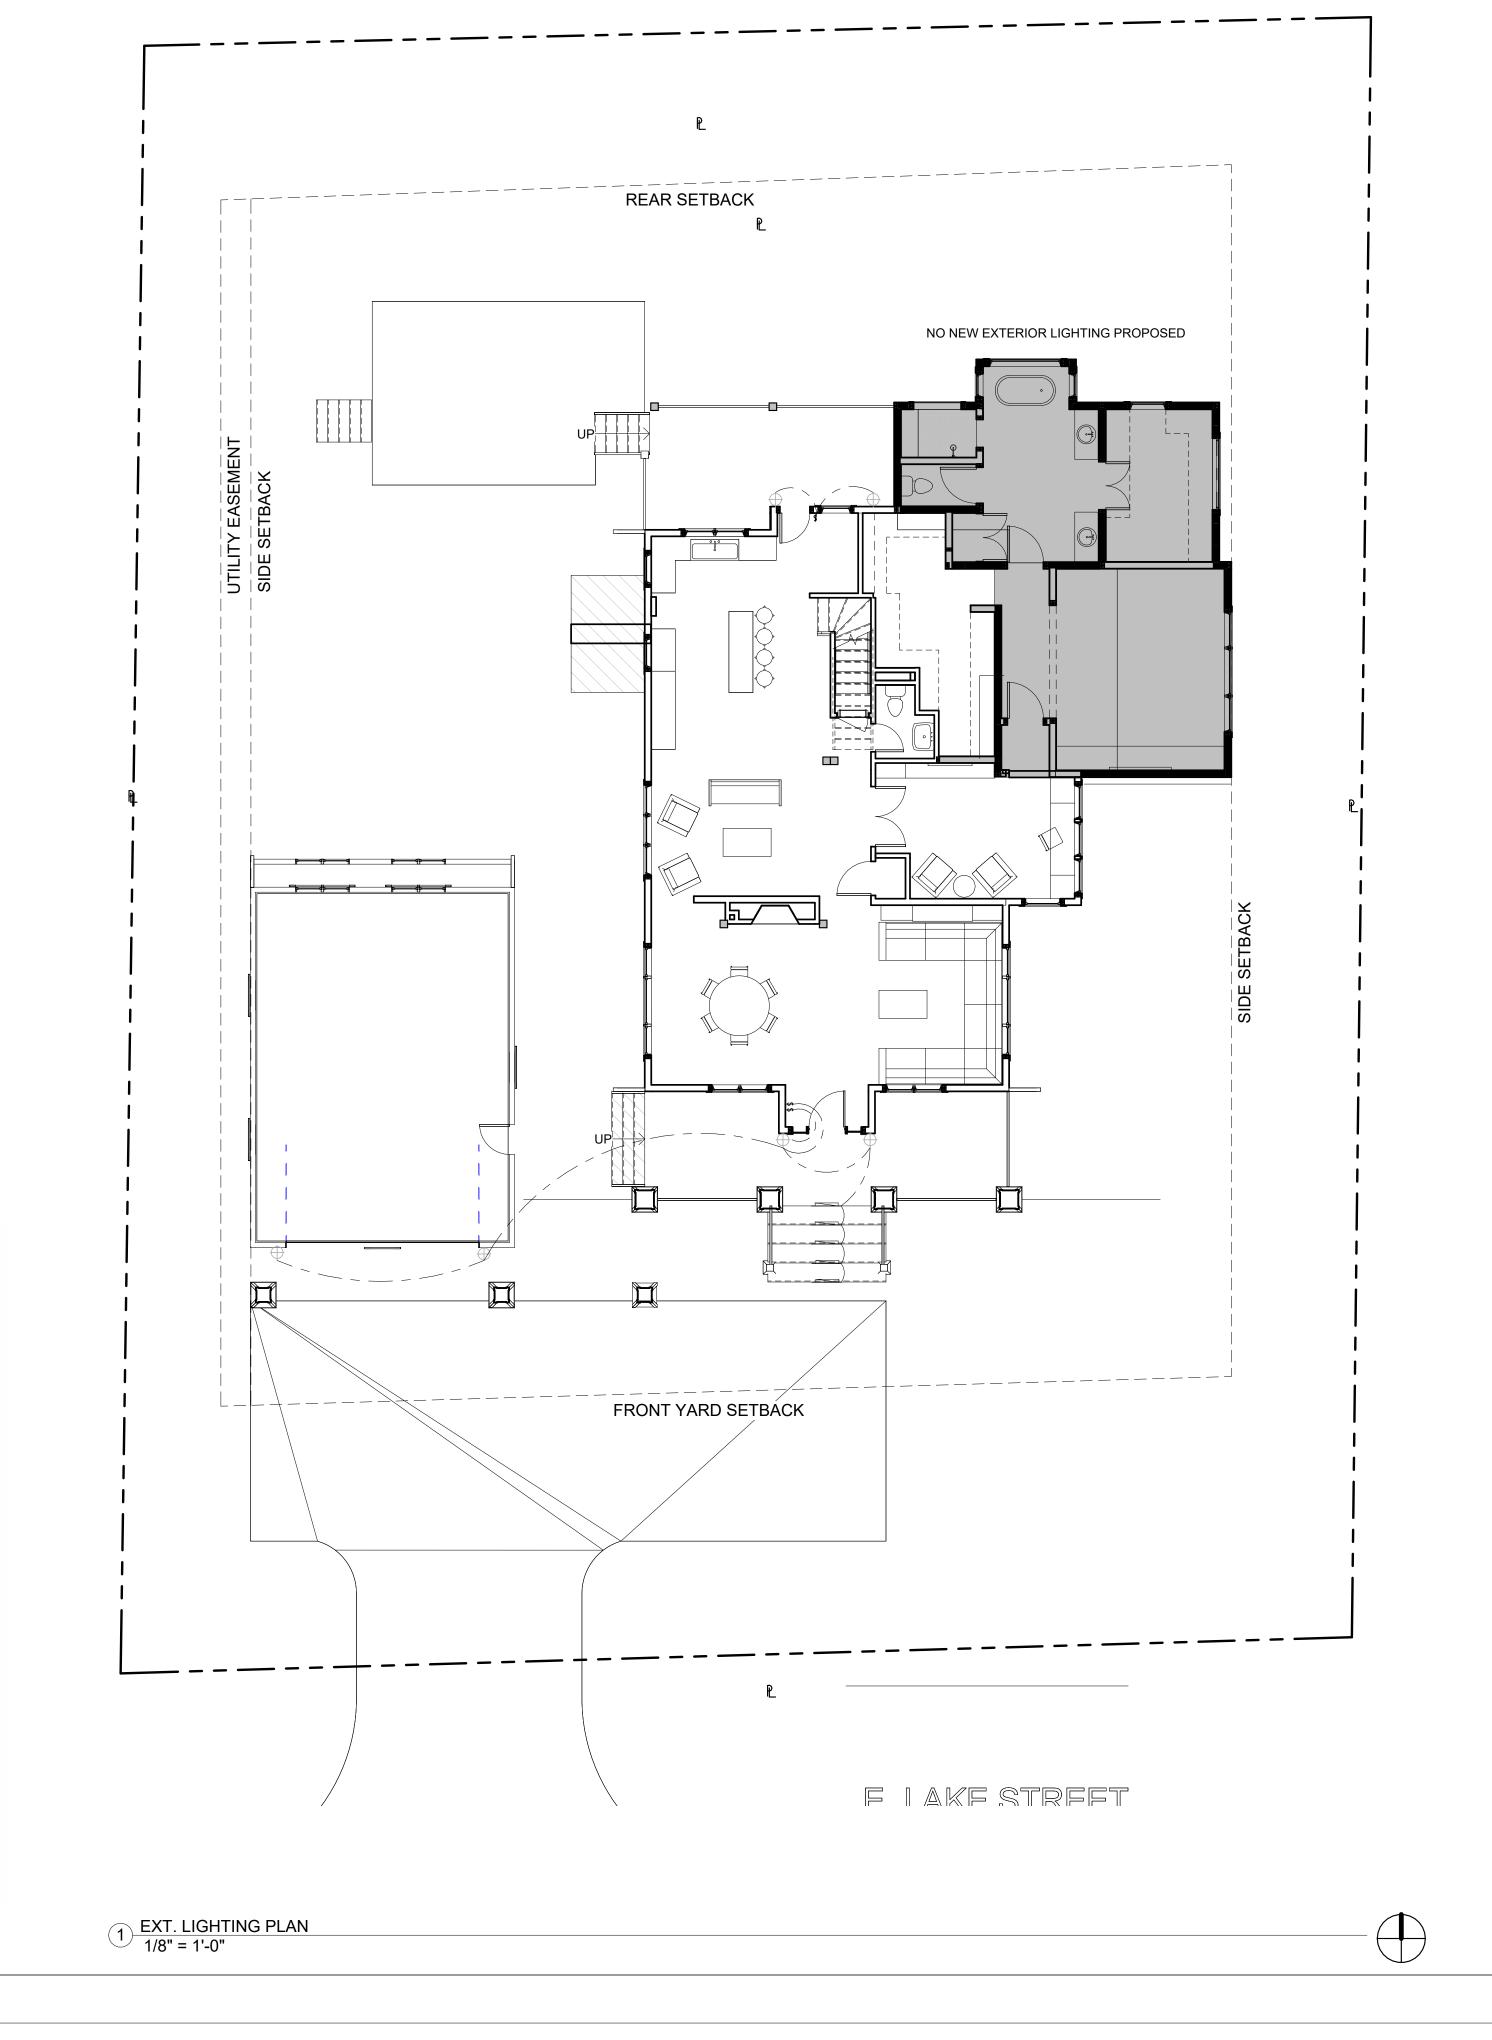
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AREA OF WORK / FOOTPRINT OF ADDITION

---- PROPERTY LINE

---- SETBACK LINE

---- (E) ELECTRICAL PATH

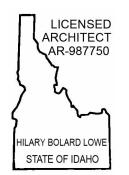
(E) EXTERIOR LIGHT FIXTURE

(E) RECESSED STEP LIGHT

\$ (E) SWITCH



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NOTES

- 1. NO OBSTRUCTIONS INCLUDING SOLID WALLS IN THE VISIBILITY AREA SHALL EXCEED 3 FEET IN HEIGHT. PLANT MATERIAL, OTHER THAN TREES, WITHIN THE PUBLIC RIGHT-OF-WAY THAT ARE LOCATED WITHIN VISIBILITY AREA SHALL NOT EXCEED 24 INCHES IN HEIGHT, MEASURED FROM THE TOP OF THE ADJACENT CURB.
- 2. THERE ARE NO SITE WALLS OR FENCES PROPOSED AND SHALL NOT BE INCLUDED IN THIS PERMIT.
- 3. THERE ARE NO EXISTING OR PROPOSED TRANSIT STOPS.
- 4. SETBACKS AT EXISTING BUILDING LOCATION ARE AS DETERMINED BY SURVEY & UNVERIFIED. SETBACKS AT PROPOSED CONSTRUCTION ARE MINIMUM DISTANCE TO PROPERTY LINE. IT SHALL BE THE CONTRACTOR'S RESPONSIBILITY TO ADHERE TO THOSE MINIMUM SETBACKS.
- 5. ALL STREET IMPROVEMENTS ARE EXISTING AND TO REMAIN AS IS. EXISTING CURB CUT AND CONCRETE APRON TO REMAIN TO SERVICE FOR EXISTING OFF-STREET PARKING.
- 6. THERE ARE NO NEW RETAINING WALLS PROPOSED.
- 7. VERIFY ALL GRADES AND CONDITIONS IN FIELD PRIOR TO STARTING WORK. NOTIFY OWNER AND ARCHITECT OF ANY DISCREPANCIES.
- 8. LOT TO DRAIN TO APPROVED DRAINAGE FACILITY. NO CONCENTRATED DRAINAGE FLOW ACROSS PROPERTY LINE. SURFACE WATER SHALL DRAIN AWAY FROM THE BUILDING 6" WITHIN THE FIRST 10 FEET.
- 9. ALL DOWNSPOUTS SHALL DRAIN TO LANDSCAPE AREAS.
- 10. VERIFY EXISTING UTILITY LOCATIONS AND NEW ELECTRIC AND GAS METER LOCATIONS BEFORE START OF CONSTRUCTION. ALL OVERHEAD UTILITIES SERVING THE SITE ARE TO BE VERIFIED AND ADJUSTED AS NECESSARY FOR THE PROPOSED ADDITION. THE EXISTING WATER AND SEWER SERVICES WILL REMAIN.
- 11. NO WORK SHALL BE PERFORMED IN THE PUBLIC EASEMENT.

DMARK RESIDENC 143 E. LAKE STREET MCCALL, IDAHO

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Drawing Title:

EXTERIOR LIGHTING PLAN

Scale:

As indicated

Sheet Number:

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Certifications/Qualifications

Electrical Supply Wire (Degrees)

Light Source
Dimmable
Lamp Included
Lamp Type
Light Source
Max or Normal Watt
of Bulba/LED Modules
Socket Type
Socket Wire

Mounting/Installation Interior/Exterior Location Rating Mounting Style

FIXTURE ATTRIBUTES

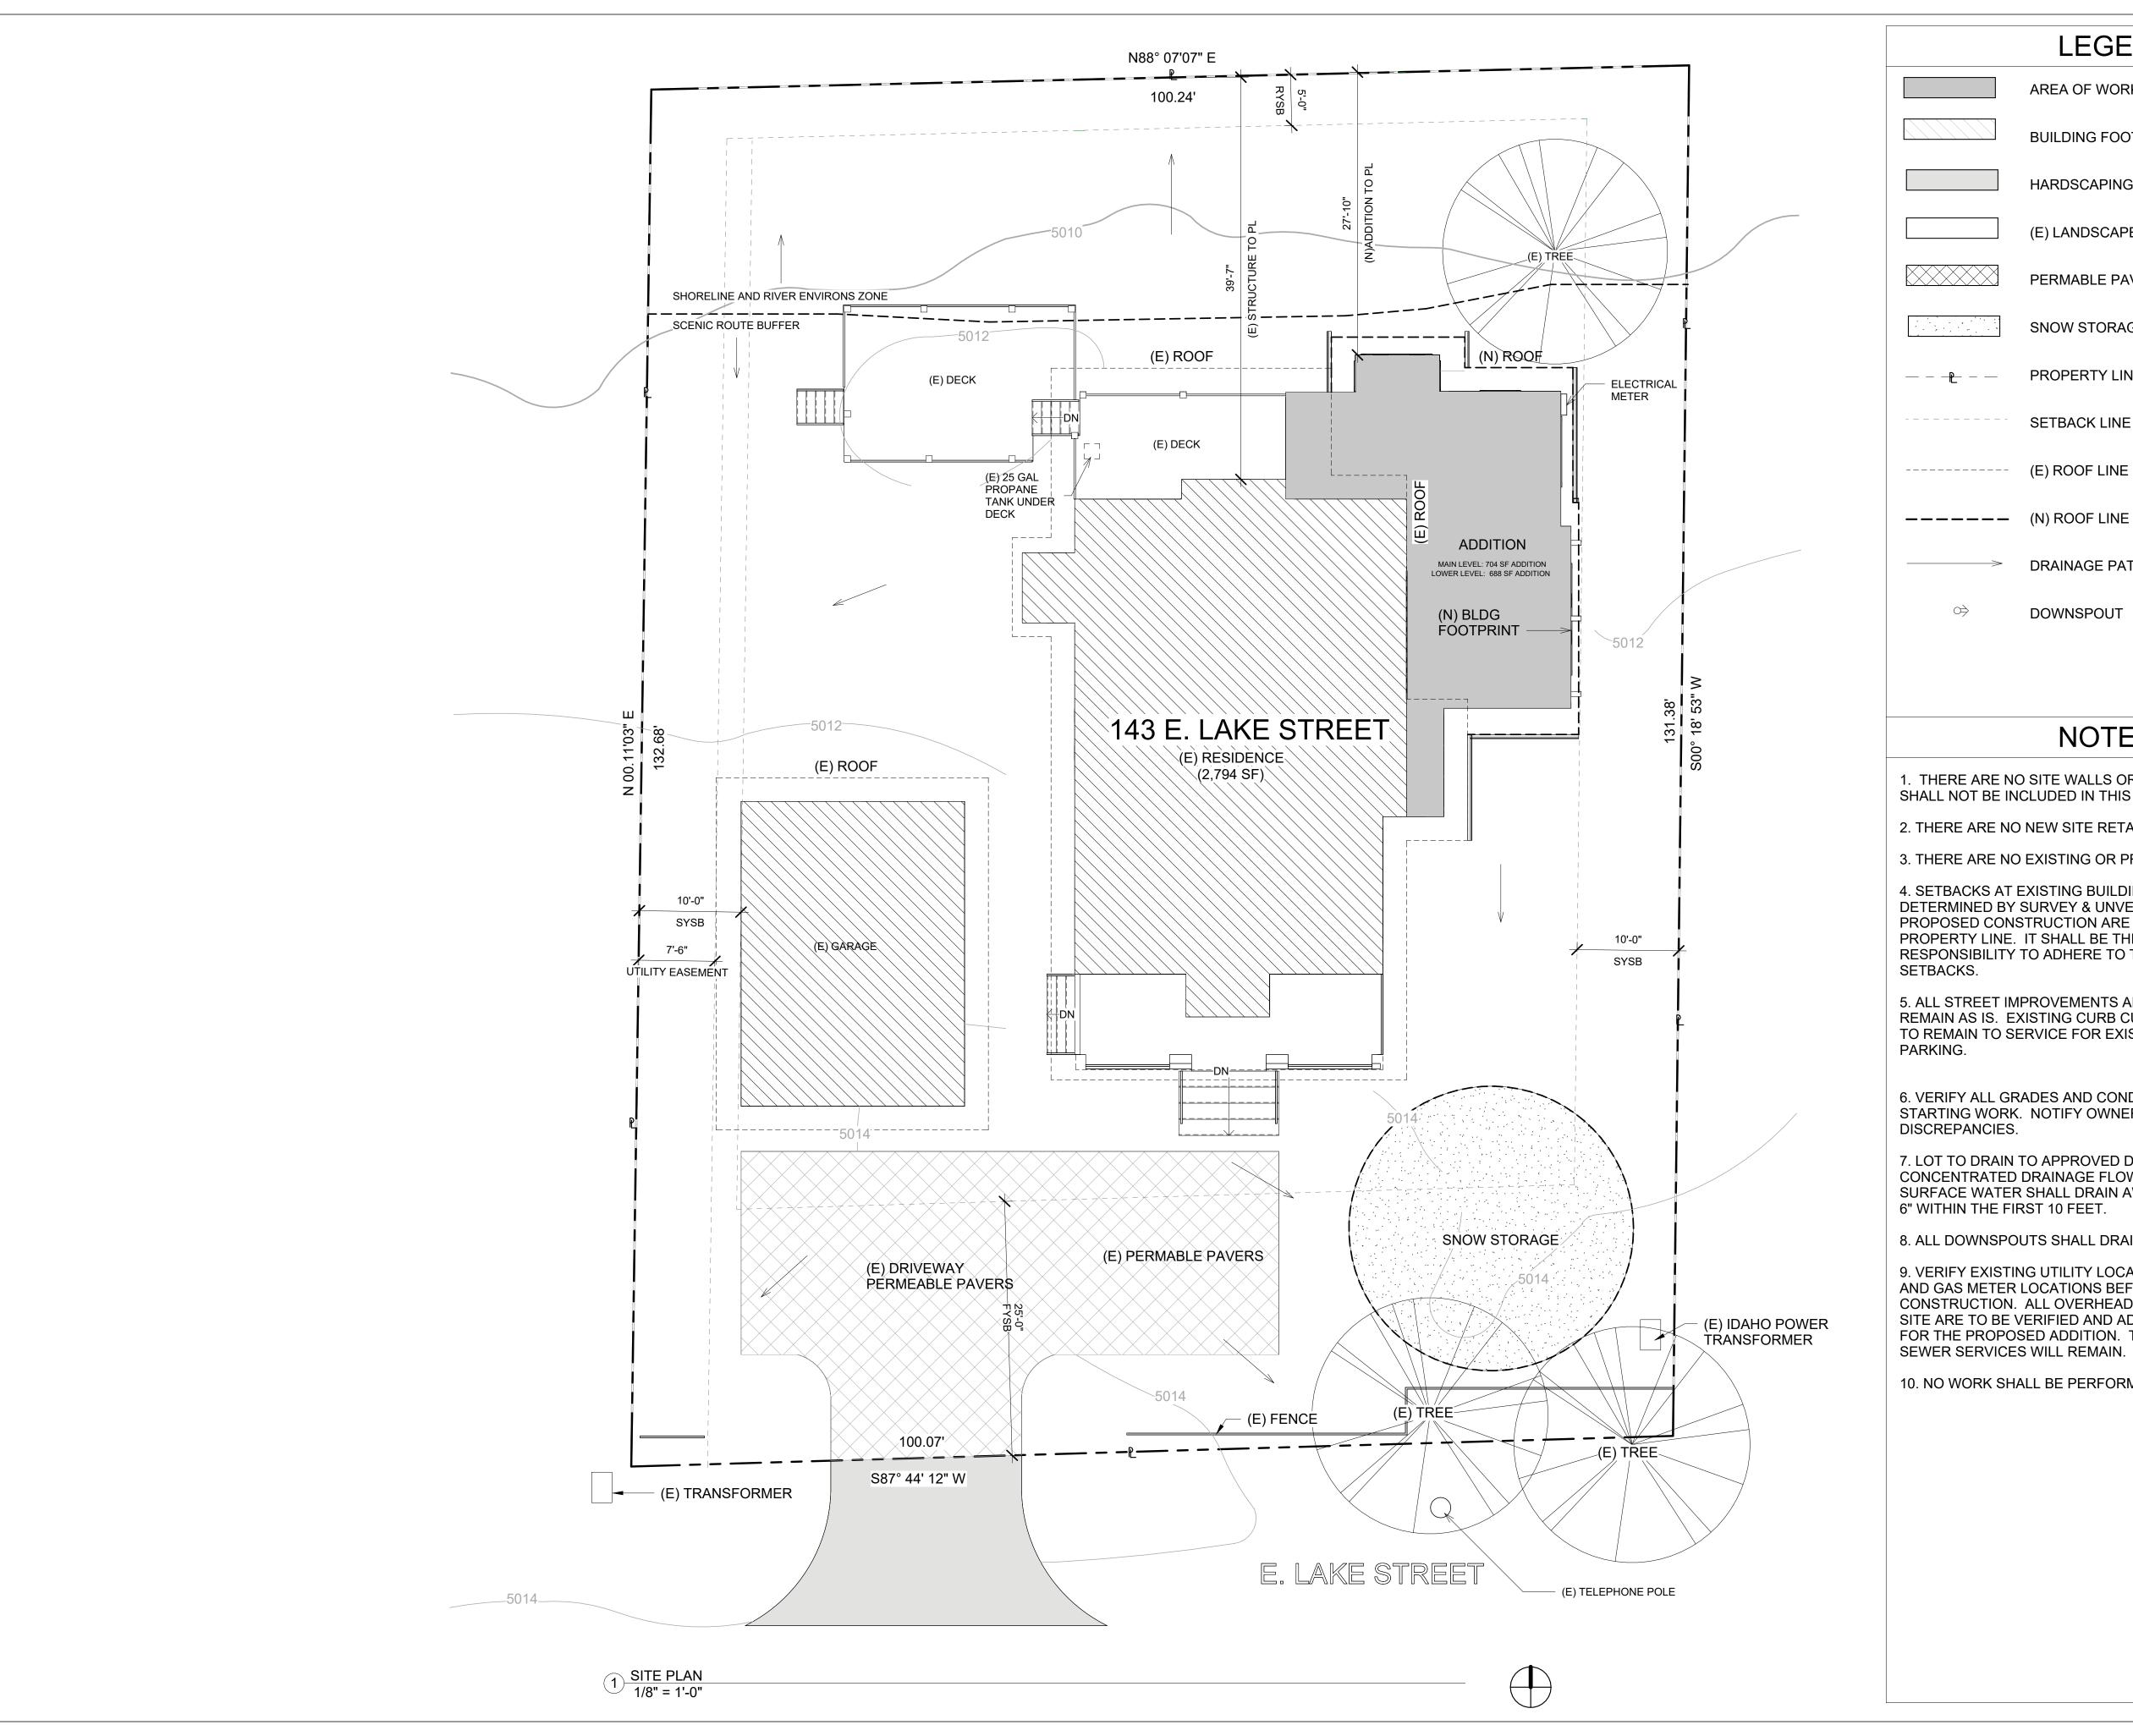
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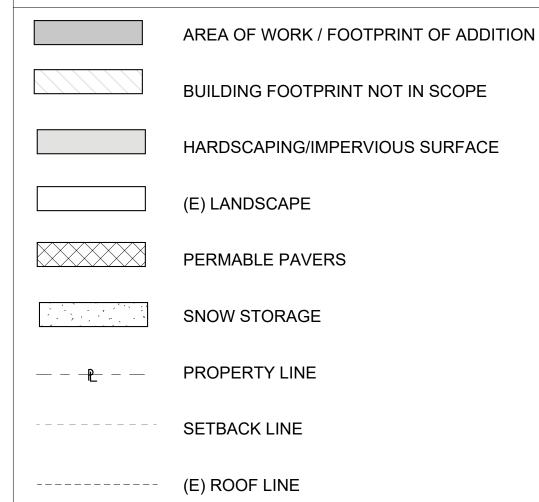
Canyon View

www.kichler.com/warranty

ALSO IN THIS FAMILY

KICHLER.





NOTES

DRAINAGE PATTERN

DOWNSPOUT

- 1. THERE ARE NO SITE WALLS OR FENCES PROPOSED AND SHALL NOT BE INCLUDED IN THIS PERMIT.
- 2. THERE ARE NO NEW SITE RETAINING WALLS PROPOSED.
- 3. THERE ARE NO EXISTING OR PROPOSED TRANSIT STOPS.
- 4. SETBACKS AT EXISTING BUILDING LOCATION ARE AS DETERMINED BY SURVEY & UNVERIFIED. SETBACKS AT PROPOSED CONSTRUCTION ARE MINIMUM DISTANCE TO PROPERTY LINE. IT SHALL BE THE CONTRACTOR'S RESPONSIBILITY TO ADHERE TO THOSE MINIMUM SETBACKS.
- 5. ALL STREET IMPROVEMENTS ARE EXISTING AND TO REMAIN AS IS. EXISTING CURB CUT AND CONCRETE APRON TO REMAIN TO SERVICE FOR EXISTING OFF-STREET
- 6. VERIFY ALL GRADES AND CONDITIONS IN FIELD PRIOR TO STARTING WORK. NOTIFY OWNER AND ARCHITECT OF ANY DISCREPANCIES.
- 7. LOT TO DRAIN TO APPROVED DRAINAGE FACILITY. NO CONCENTRATED DRAINAGE FLOW ACROSS PROPERTY LINE. SURFACE WATER SHALL DRAIN AWAY FROM THE BUILDING -6" WITHIN THE FIRST 10 FEET.
- 8. ALL DOWNSPOUTS SHALL DRAIN TO LANDSCAPE AREAS.
- 9. VERIFY EXISTING UTILITY LOCATIONS AND NEW ELECTRIC AND GAS METER LOCATIONS BEFORE START OF CONSTRUCTION. ALL OVERHEAD UTILITIES SERVING THE SITE ARE TO BE VERIFIED AND ADJUSTED AS NECESSARY FOR THE PROPOSED ADDITION. THE EXISTING WATER AND SEWER SERVICES WILL REMAIN.
- 10. NO WORK SHALL BE PERFORMED IN UTILITY EASEMENT.



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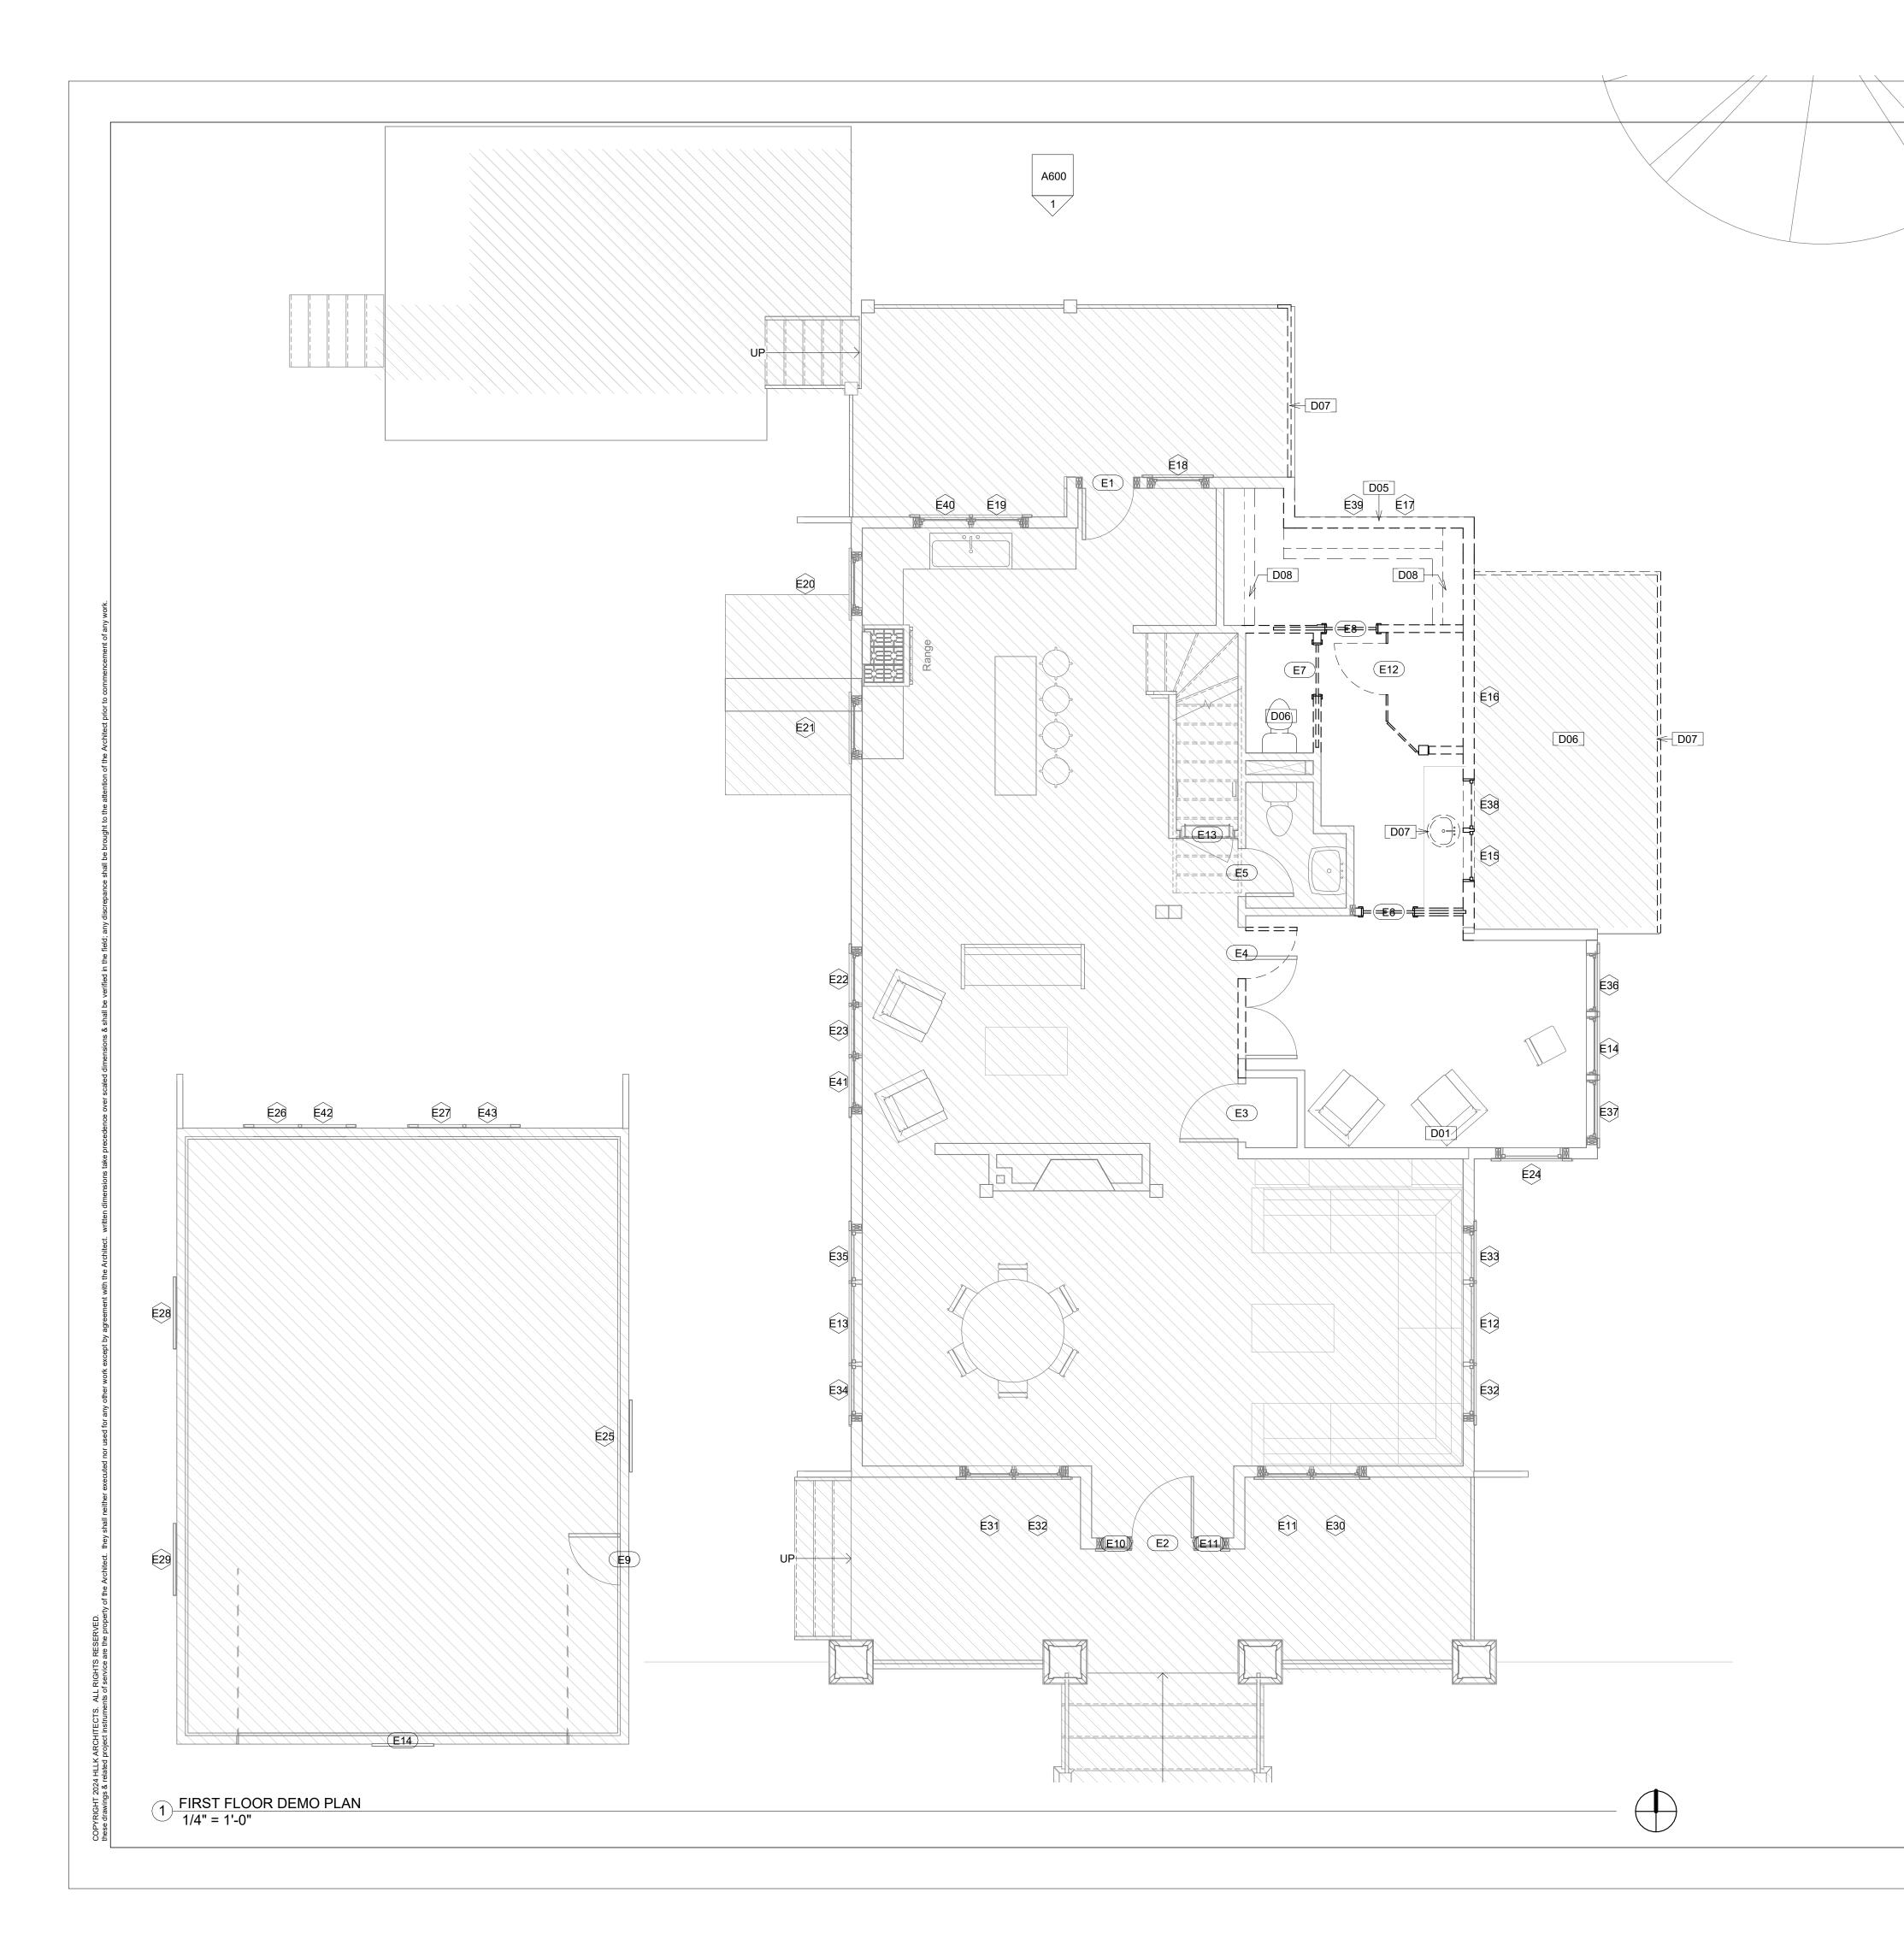
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Drawing Title:

SITE PLAN

Scale:

As indicated



EXISTING TO BE DEMOLISHED

NOT IN SCOPE

(1i)

WINDOW TAG, REFER TO SCHEDULE

101

DOOR TAG, REFER TO SCHEDULE

KEYNOTES

D01	DEMO (E) FINISH, WOOD FRAMING TO REMAIN AS IS.
D05	DEMO (E) WINDOW AND PORTION OF WALL
D06	DEMO (E) DECK
D07	DEMO (E) RAILING
D08	DEMO (E) CABINETRY

NOTES

- 1. THE CONTRACTOR SHALL VERIFY AND ACQUAINT THEMSELVES WITH THE EXISTING CONDITIONS PRIOR TO CONSTRUCTION; INCLUDING BUT NOT LIMITED TO INVESTIGATION OF EXISTING FOOTINGS, FOUNDATION WALLS, RAISED FLOORS AND SLABS.
- 2. CONTRACTOR TO VERIFY FIELD CONDITIONS WITH ARCHITECTURE AND STRUCTURAL PLANS AND SPECIFICATIONS.
- 3. VERIFY IN FIELD WITH ARCHITECT WALLS AND STRUCTURAL ELEMENTS TO BE REMOVED.
- 4. THE OWNER SHALL REMOVE OR IDENTIFY ITEMS THAT THEY WILL RETAIN PRIOR TO THE START OF DEMOLITION. THE REMAINING ITEMS DEMOLISHED BECOME THE PROPERTY OF THE CONTRACTOR AND MUST BE DISPOSED OF PROPERLY OFF-SITE.
- 5. CONTRACTOR SHALL ALLOW FOR CONNECTIONS TO EXISTING PLUMBING AND SEWER LOCATIONS.
- 6. REMOVE ALL LANDSCAPE/HARDSCAPE WHERE INDICATED FOR NEW CONSTRUCTION. PROTECT IN PLACE ALL EXISTING LANDSCAPE/HARDSCAPE TO REMAIN.
- 7. REMOVE ALL EXISTING CONSTRUCTIONS AND FINISHES NECESSARY FOR THE COMPLETION OF THE WORK AS DEPICTED ON THE DRAWINGS, INCLUDING BUT NOT LIMITED TO, ITEMS SHOWN ON THE PLANS TO BE DEMOLISHED. NECESSARY DISCONNECTS AND ALTERATIONS TO EXISTING MECHANICAL AND ELECTRICAL SYSTEMS SHALL BE INCLUDED. CAP OFF OR TIE OFF TO INSURE THE SAFETY OF INDIVIDUALS IN THIS AREA. PATCH AS REQUIRED ALL CONSTRUCTIONS TO REMAIN IN ACCORDANCE WITH THE CONTRACT DRAWINGS.
- 8. THE CONTRACTOR SHALL PROTECT OCCUPIED AREA FROM DUST AND DEBRIS. MAINTAIN BUILDING SYSTEMS NECESSARY TO SUPPORT OCCUPIED AREAS.
- 9. PROTECT IN PLACE ALL EXISTING TO REMAIN. THE CONTRACTOR SHALL PROVIDE ADEQUATE PROTECTION TO ALL EXISTING WORK, FURNISHINGS, AND FIXTURES / APPLIANCES THAT ARE TO BE RETAINED TO PREVENT DAMAGE.
- 10. PATCH ALL FINISHES TO MATCH EXISTING. VERIFY MATCH WITH OWNER AND/OR ARCHITECT.
- 11. ALL DEMOLISHED ITEMS AND MATERIALS TO BE REMOVED FROM SITE AND SAFELY DISPOSED OF IN ACCORDANCE WITH APPLICABLE LAWS AND REGULATIONS, UNLESS SPECIFIED OTHERWISE BY OWNER.



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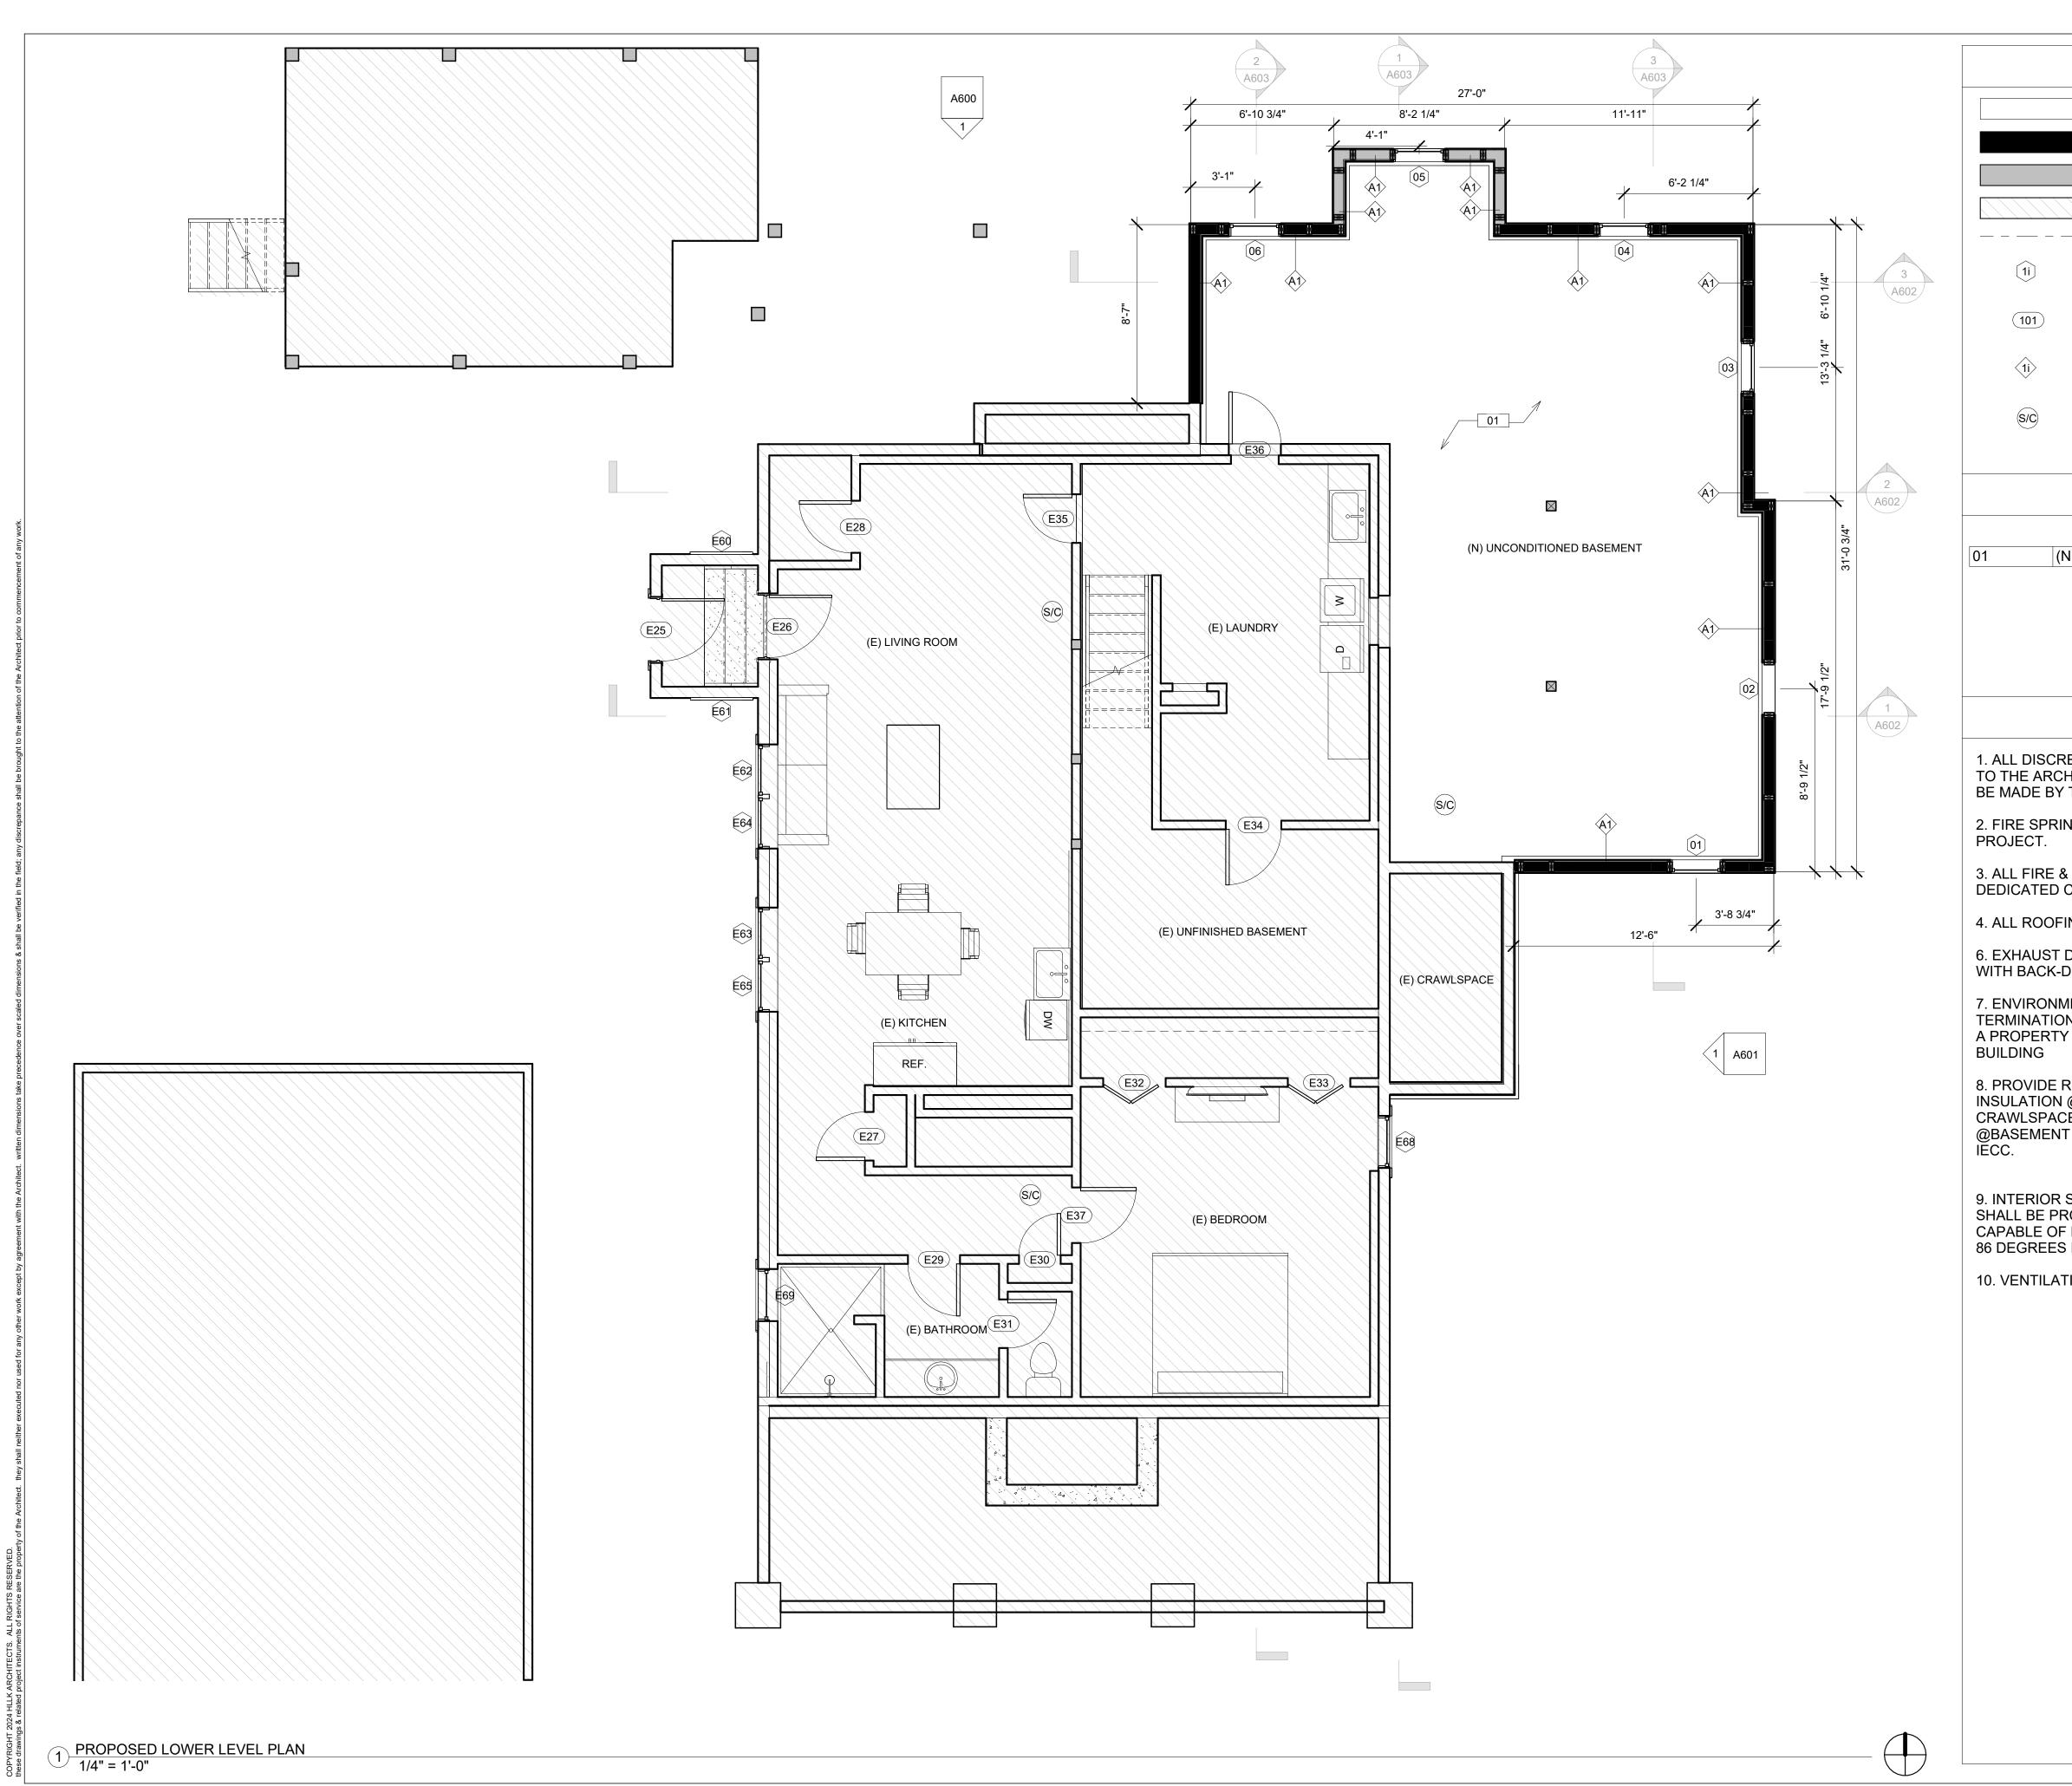
FIRST FLOOR DEMO PLAN

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NEW SHEAR WALL, REFER TO STRUCTURAL
NEW WALL

NOT IN SCOPE

PROPERTY LINE

WINDOW TAG, REFER TO SCHEDULE

DOOR TAG, REFER TO SCHEDULE

WALL TAG, REFER TO SCHEDULE

SMOKE DETECTOR/CO ALARM

KEYNOTES

(N) SLAB PER STRUCTURAL

NOTES

1. ALL DISCREPANCIES IN DIMENSIONS SHALL BE REPORTED TO THE ARCHITECT. ALL CHANGES / CLARIFICATIONS SHALL BE MADE BY THE ARCHITECT'S REPRESENTATIVE.

2. FIRE SPRINKLERS ARE NOT REQUIRED FOR THIS PROJECT

3. ALL FIRE & CARBON MONOXIDE ALARMS TO BE ON A DEDICATED CIRCUIT.

4. ALL ROOFING TO BE 'CLASS A'.

6. EXHAUST DUCTS AND DRYER VENTS SHALL BE EQUIPPED WITH BACK-DRAFT DAMPERS.

7. ENVIRONMENTAL AIR DUCTS AND EXHAUST TERMINATIONS SHALL TERMINATE NOT LESS THAN 3' FROM A PROPERTY LINE AND 3' FROM OPENINGS INTO THE BUILDING

8. PROVIDE R-20 CAVITY INSULATION PLUS R-5 CONTINUOUS INSULATION @ (N) WALLS, R-30 INSULATION @ (N) CRAWLSPACE & (N) FLOORS, R-19 CAVITY INSULATION @BASEMENT WALLS, & R-49 INSULATION @ (N) ROOFS PER

9. INTERIOR SPACES INTENDED FOR HUMAN OCCUPANCY SHALL BE PROVIDED WITH A SPACE-HEATING SYSTEM CAPABLE OF MAINTAINING A MIN. INDOOR TEMPERATURE OF 86 DEGREES F.

10. VENTILATION FANS TO PROVIDE A MINIMUM OF 50 CFMS.



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PROPOSED LOWER LEVEL PLAN

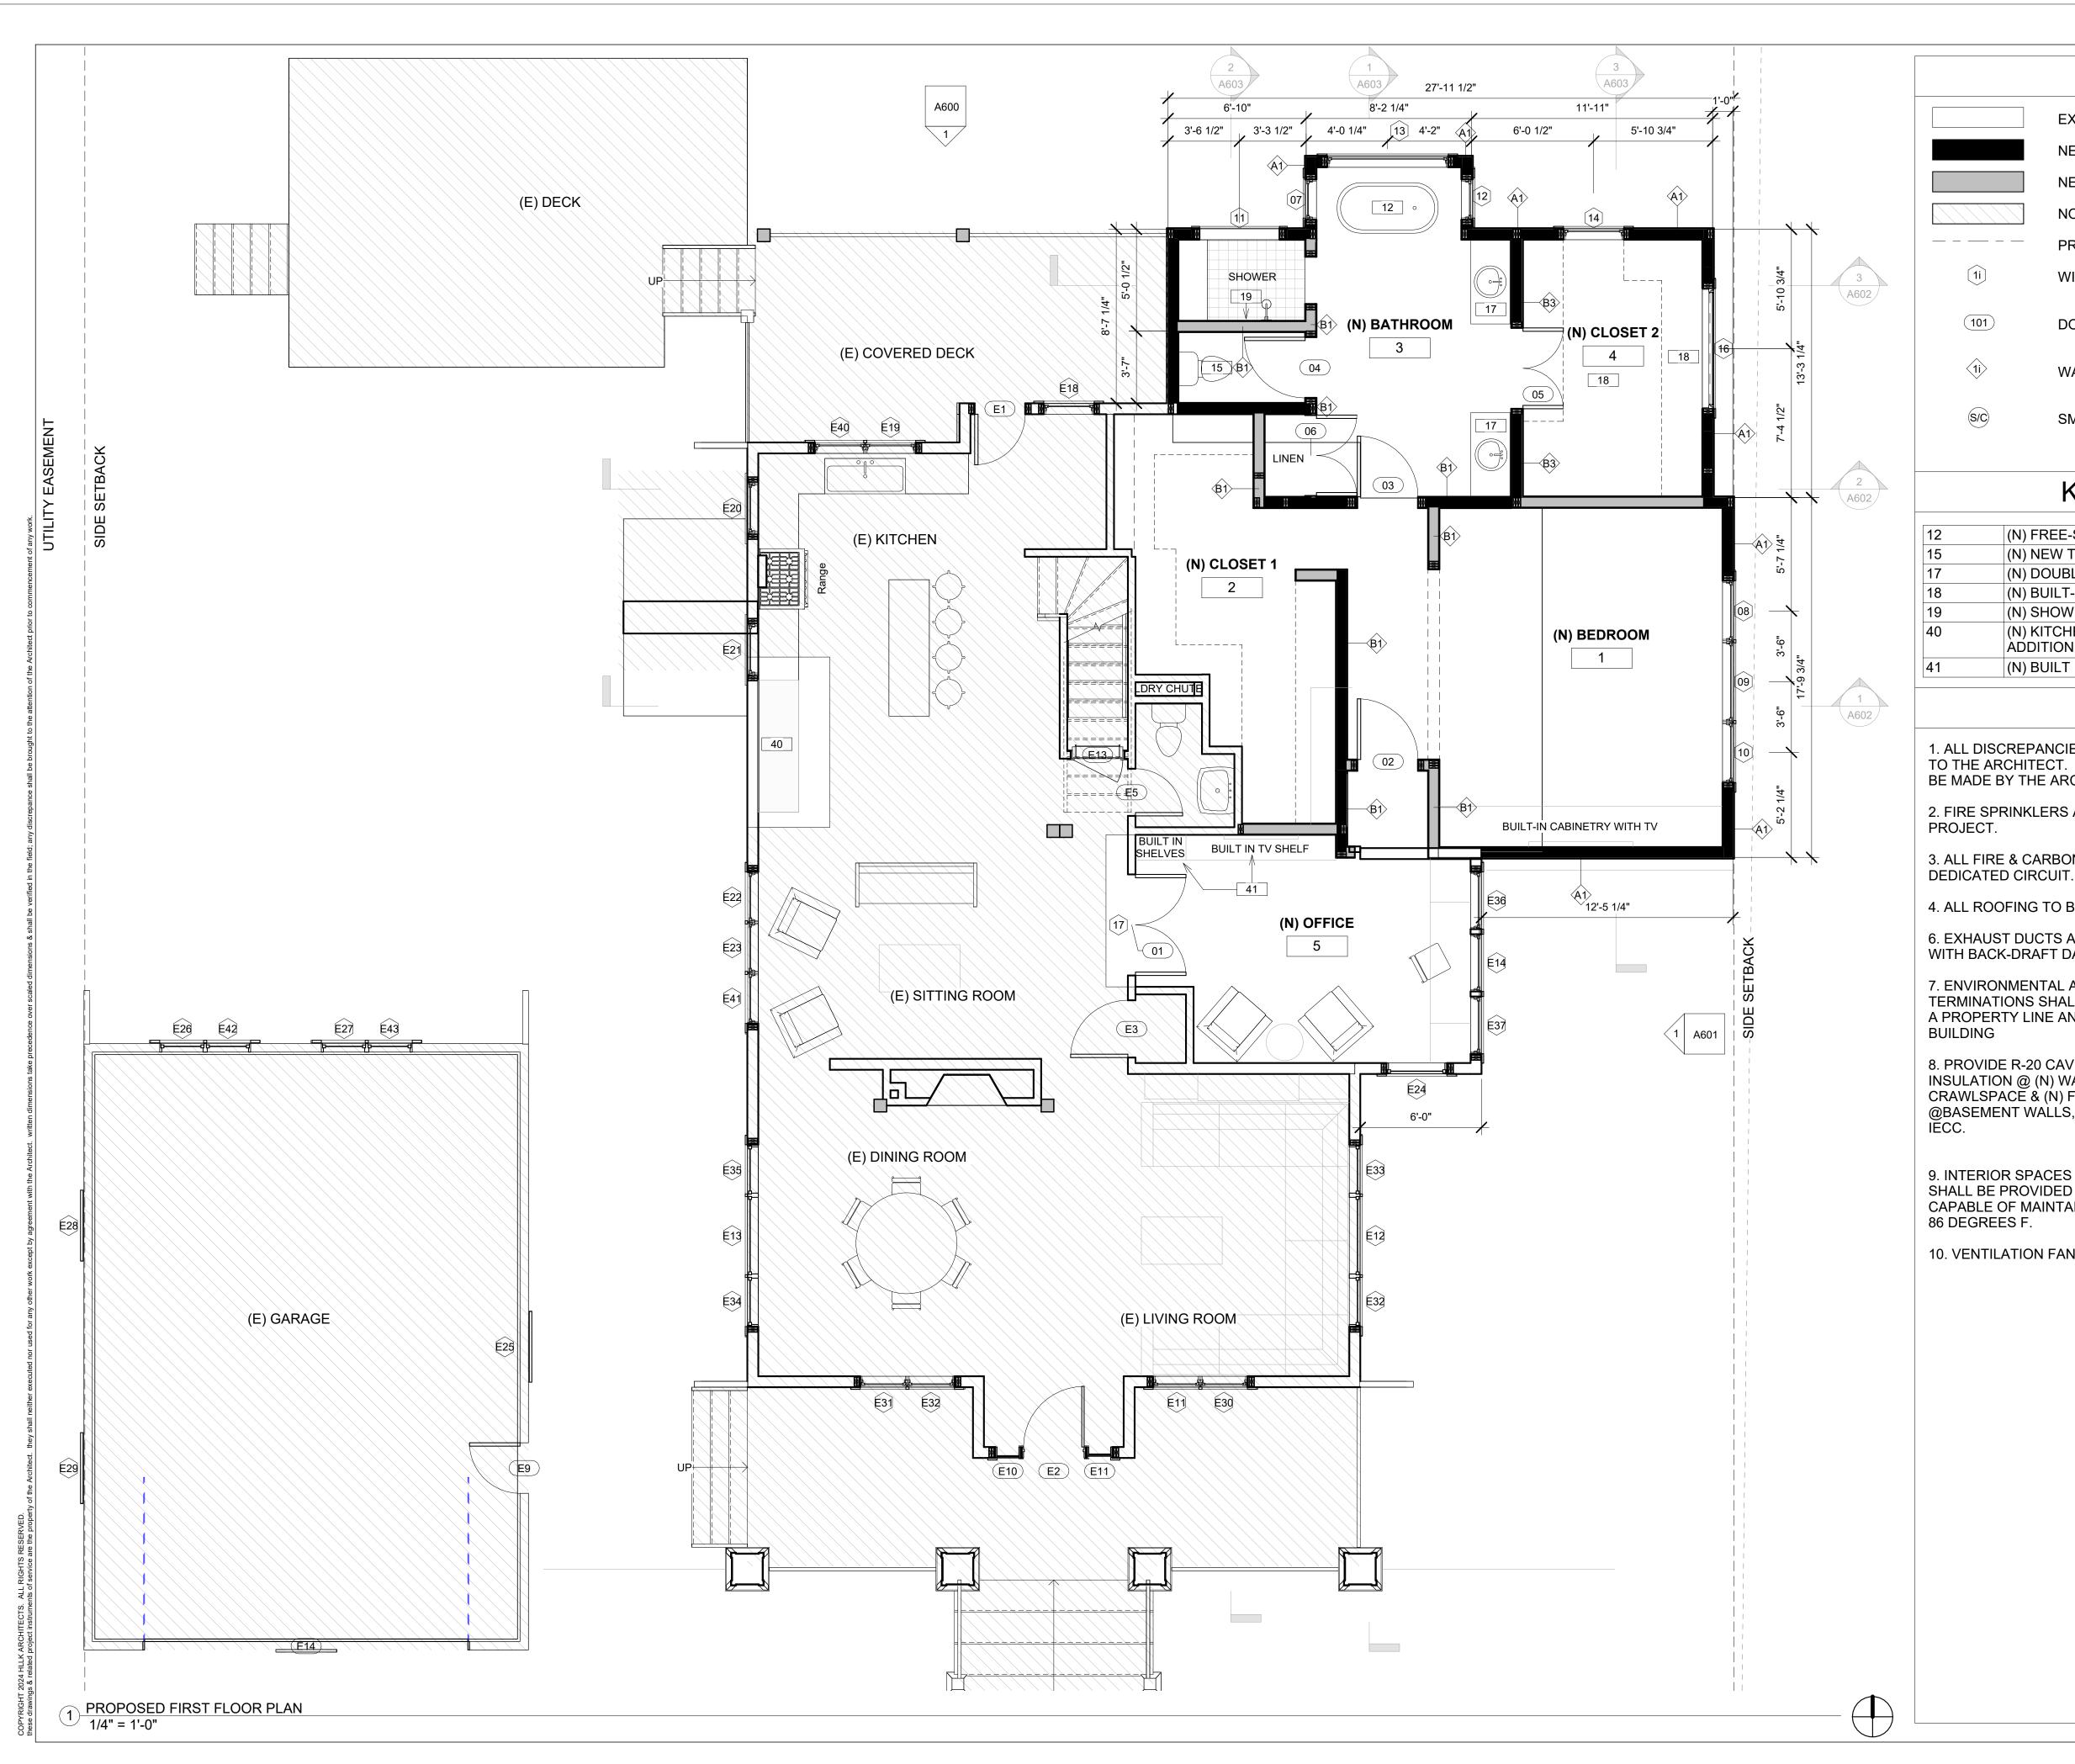
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EXISTING TO REMAIN NEW SHEAR WALL, REFER TO STRUCTURAL **NEW WALL**

NOT IN SCOPE PROPERTY LINE

WINDOW TAG, REFER TO SCHEDULE

101 DOOR TAG, REFER TO SCHEDULE

WALL TAG, REFER TO SCHEDULE

SMOKE DETECTOR/CO ALARM

KEYNOTES

12	(N) FREE-STANDING BATH TUB
15	(N) NEW TOILET TBD
17	(N) DOUBLE BATHROOM SINK TBD
18	(N) BUILT-IN CLOSET SHELVING TBD
19	(N) SHOWER HEAD TBD
40	(N) KITCHEN CABINET AND COUNTERTOP ADDITION TO MATCH EXISTING
41	(N) BUILT IN CASEWORK

NOTES

1. ALL DISCREPANCIES IN DIMENSIONS SHALL BE REPORTED TO THE ARCHITECT. ALL CHANGES / CLARIFICATIONS SHALL BE MADE BY THE ARCHITECT'S REPRESENTATIVE.

2. FIRE SPRINKLERS ARE NOT REQUIRED FOR THIS

3. ALL FIRE & CARBON MONOXIDE ALARMS TO BE ON A

4. ALL ROOFING TO BE 'CLASS A'.

6. EXHAUST DUCTS AND DRYER VENTS SHALL BE EQUIPPED WITH BACK-DRAFT DAMPERS.

7. ENVIRONMENTAL AIR DUCTS AND EXHAUST TERMINATIONS SHALL TERMINATE NOT LESS THAN 3' FROM A PROPERTY LINE AND 3' FROM OPENINGS INTO THE

8. PROVIDE R-20 CAVITY INSULATION PLUS R-5 CONTINUOUS INSULATION @ (N) WALLS, R-30 INSULATION @ (N) CRAWLSPACE & (N) FLOORS, R-19 CAVITY INSULATION @BASEMENT WALLS, & R-49 INSULATION @ (N) ROOFS PER

9. INTERIOR SPACES INTENDED FOR HUMAN OCCUPANCY SHALL BE PROVIDED WITH A SPACE-HEATING SYSTEM CAPABLE OF MAINTAINING A MIN. INDOOR TEMPERATURE OF 86 DEGREES F.

10. VENTILATION FANS TO PROVIDE A MINIMUM OF 50 CFMS.



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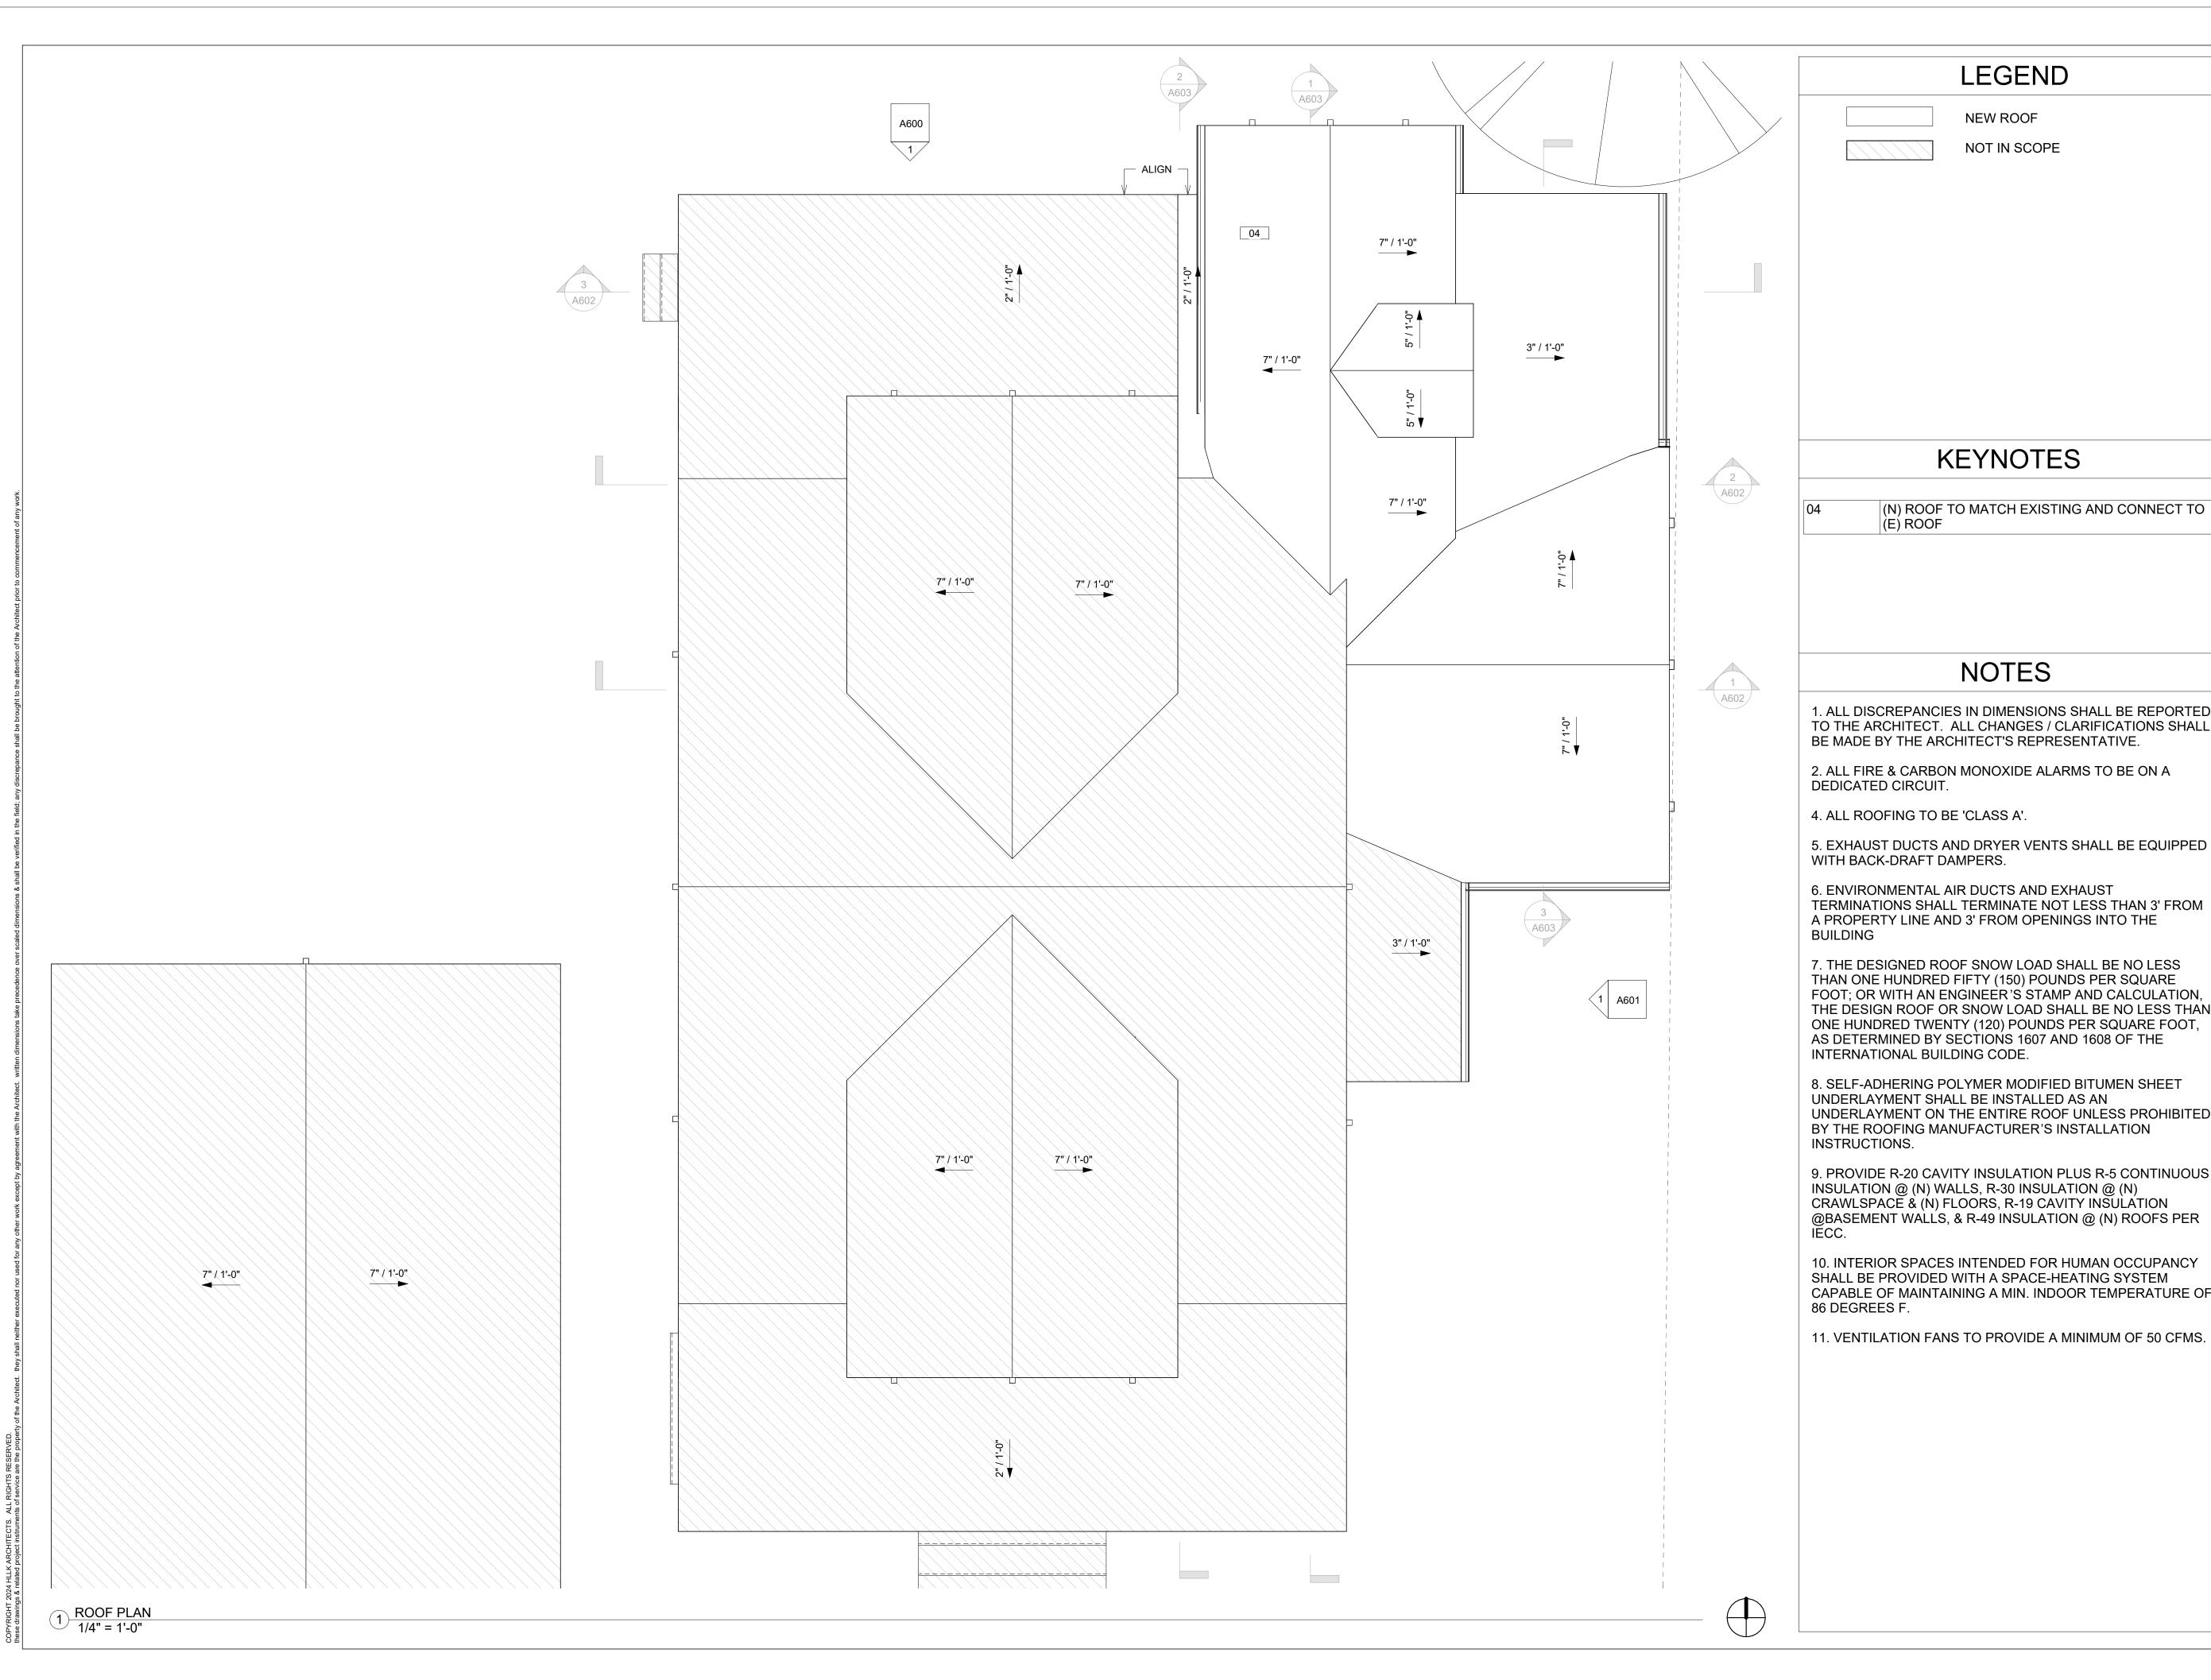
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PROPOSED FIRST FLOOR PLAN

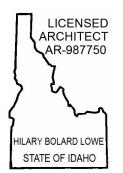
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NEW ROOF

NOT IN SCOPE

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NOTES

KEYNOTES

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2. ALL FIRE & CARBON MONOXIDE ALARMS TO BE ON A DEDICATED CIRCUIT.

4. ALL ROOFING TO BE 'CLASS A'.

5. EXHAUST DUCTS AND DRYER VENTS SHALL BE EQUIPPED WITH BACK-DRAFT DAMPERS.

6. ENVIRONMENTAL AIR DUCTS AND EXHAUST TERMINATIONS SHALL TERMINATE NOT LESS THAN 3' FROM A PROPERTY LINE AND 3' FROM OPENINGS INTO THE

7. THE DESIGNED ROOF SNOW LOAD SHALL BE NO LESS THAN ONE HUNDRED FIFTY (150) POUNDS PER SQUARE FOOT; OR WITH AN ENGINEER'S STAMP AND CALCULATION, THE DESIGN ROOF OR SNOW LOAD SHALL BE NO LESS THAN ONE HUNDRED TWENTY (120) POUNDS PER SQUARE FOOT, AS DETERMINED BY SECTIONS 1607 AND 1608 OF THE INTERNATIONAL BUILDING CODE.

8. SELF-ADHERING POLYMER MODIFIED BITUMEN SHEET UNDERLAYMENT SHALL BE INSTALLED AS AN UNDERLAYMENT ON THE ENTIRE ROOF UNLESS PROHIBITED BY THE ROOFING MANUFACTURER'S INSTALLATION INSTRUCTIONS.

9. PROVIDE R-20 CAVITY INSULATION PLUS R-5 CONTINUOUS INSULATION @ (N) WALLS, R-30 INSULATION @ (N) CRAWLSPACE & (N) FLOORS, R-19 CAVITY INSULATION @BASEMENT WALLS, & R-49 INSULATION @ (N) ROOFS PER

10. INTERIOR SPACES INTENDED FOR HUMAN OCCUPANCY SHALL BE PROVIDED WITH A SPACE-HEATING SYSTEM CAPABLE OF MAINTAINING A MIN. INDOOR TEMPERATURE OF 86 DEGREES F.

11. VENTILATION FANS TO PROVIDE A MINIMUM OF 50 CFMS.

RESIDENCE 143 E. MCC/

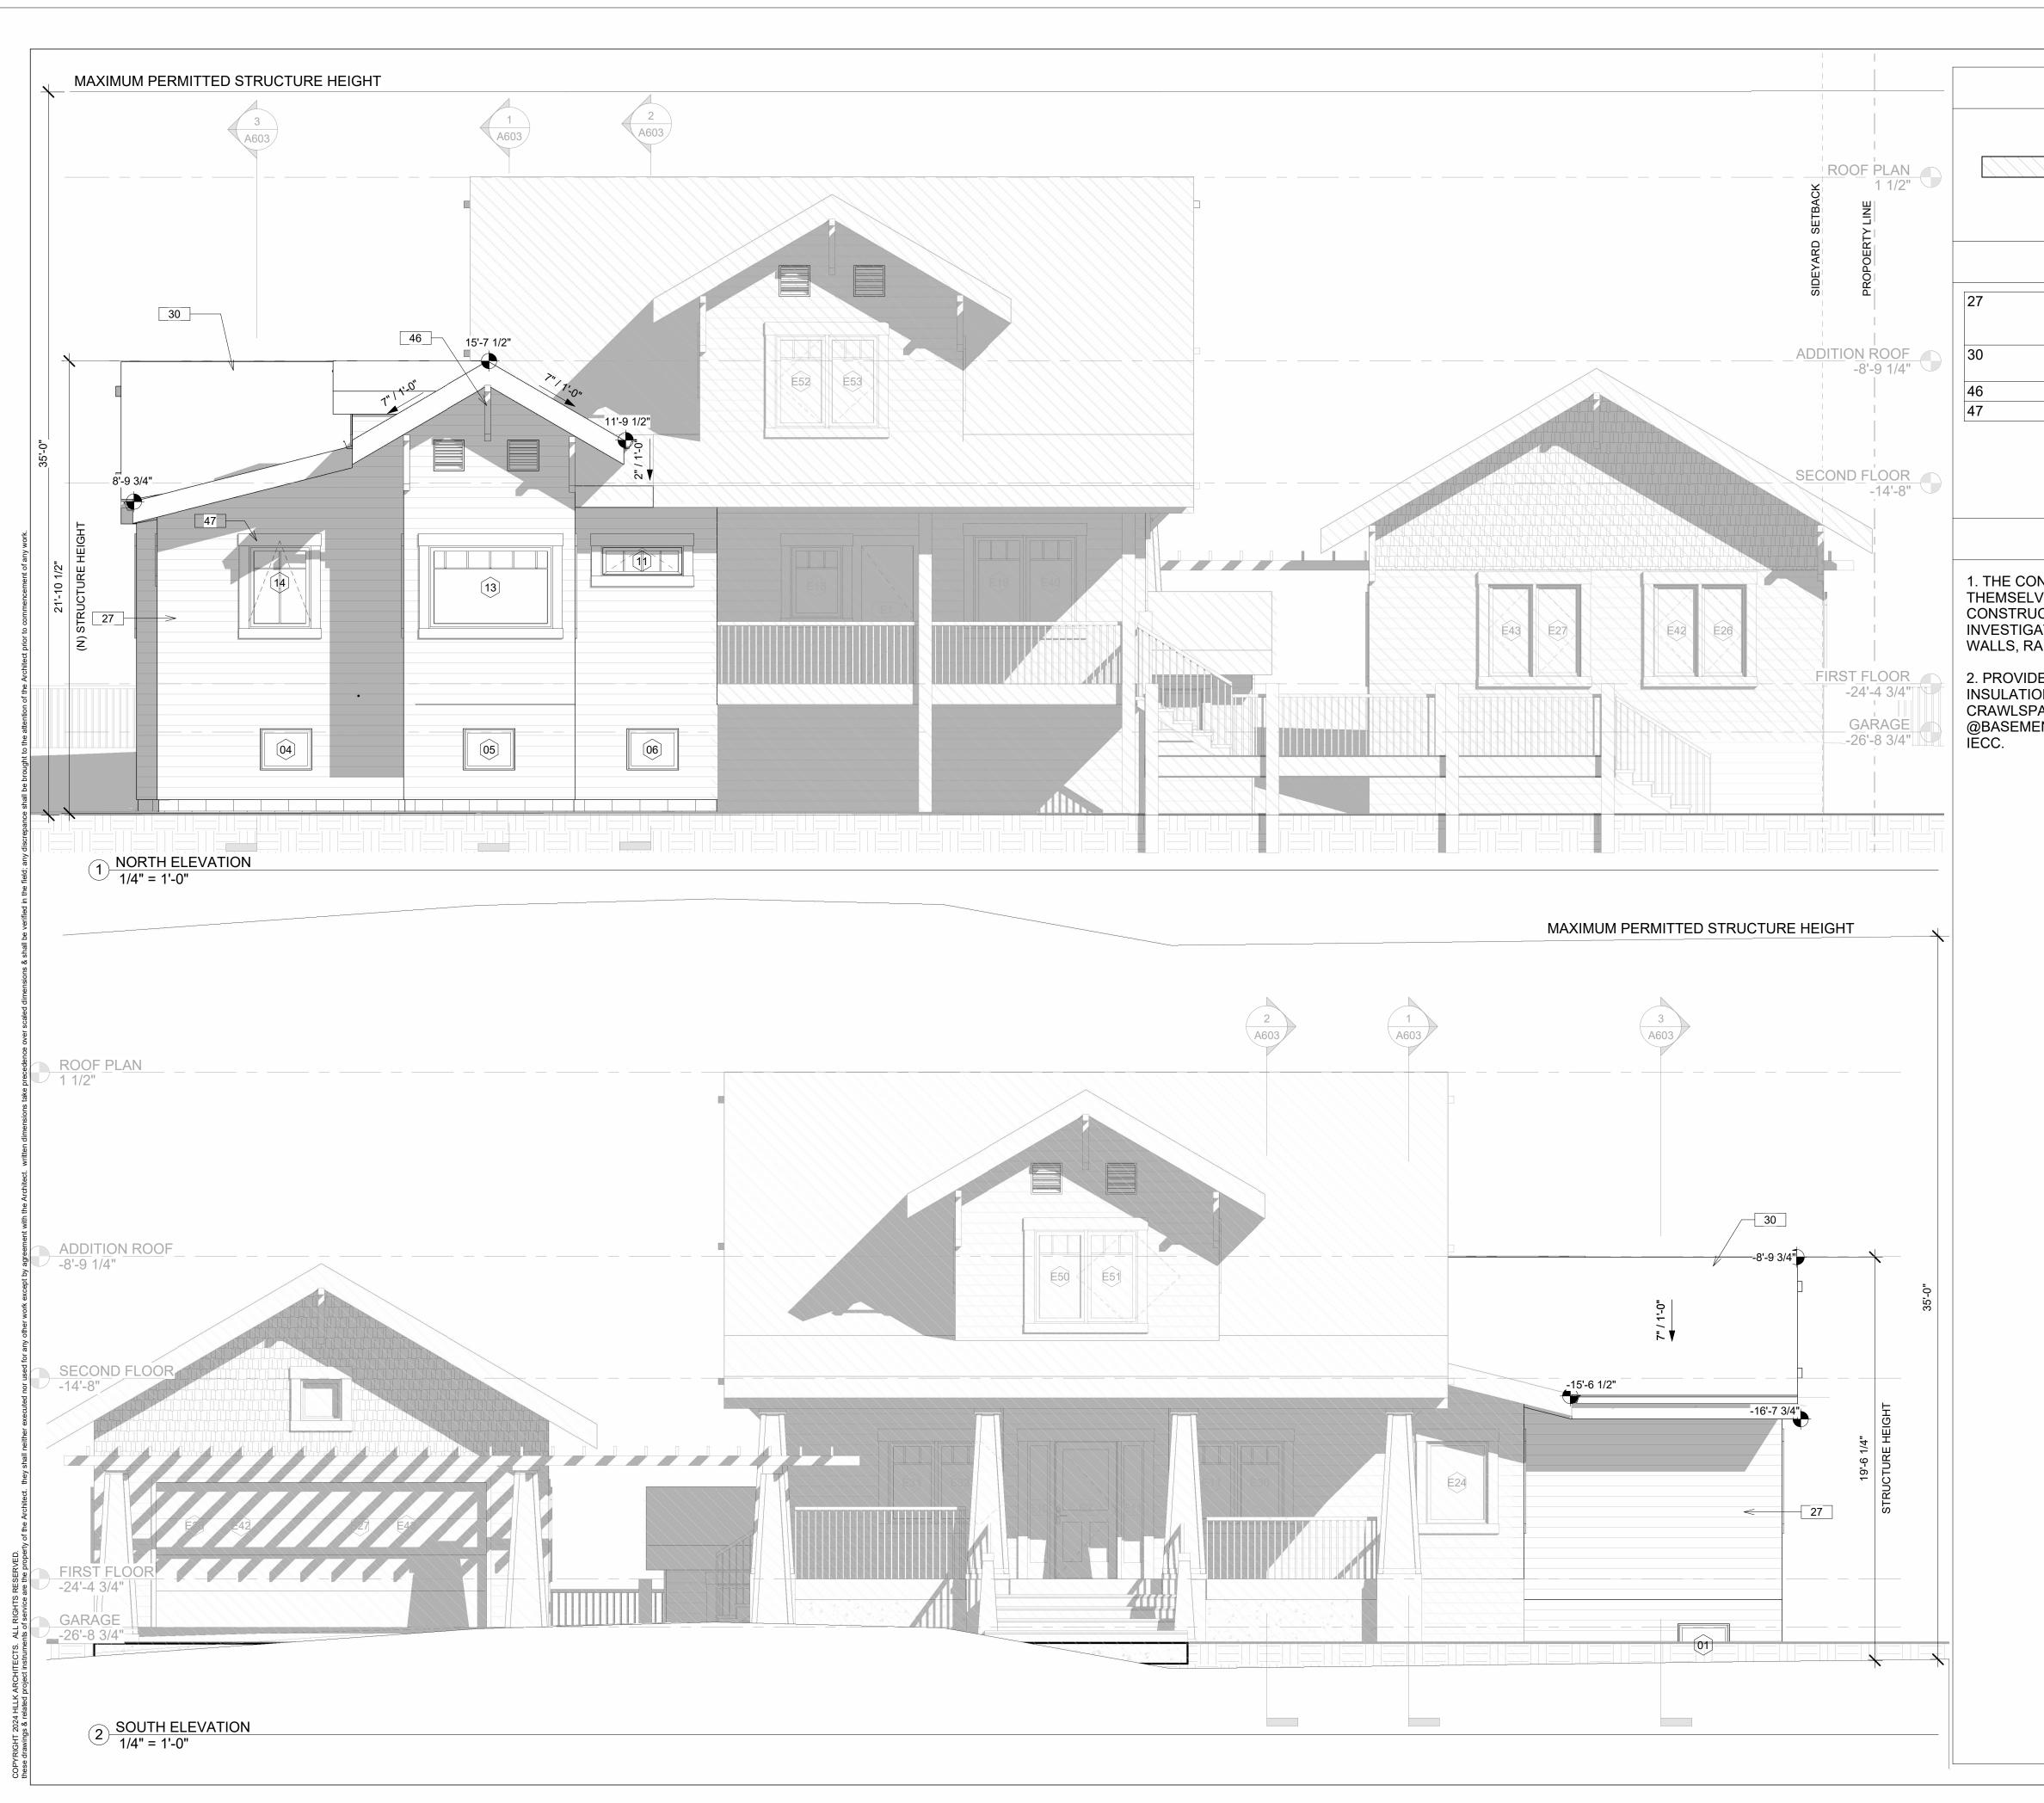
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ROOF PLAN

Scale:

1/4" = 1'-0"



NOT IN SCOPE

KEYNOTES

27 (N) HORIZONTAL SIDING 1X4 CLAPBOARD,
PAINTED BY SHERWIN WILLIAMS "COOL
DECEMBER CHARCOAL" TO MATCH EXISTING

30 (N) PRESIDENTIAL COMPOSITION SHINGLES
COLOR BLACK TO MATCH EXISTING

46 (N) KNEE BRACE DOUGLAS FIR, PAINTED WHITE

47 (N) WOOD TRIM PAINTED WHITE

NOTES

1. THE CONTRACTOR SHALL VERIFY AND ACQUAINT THEMSELVES WITH THE EXISTING CONDITIONS PRIOR TO CONSTRUCTION; INCLUDING BUT NOT LIMITED TO INVESTIGATION OF EXISTING FOOTINGS, FOUNDATION WALLS, RAISED FLOORS AND SLABS.

2. PROVIDE R-20 CAVITY INSULATION PLUS R-5 CONTINUOUS INSULATION @ (N) WALLS, R-30 INSULATION @ (N) CRAWLSPACE & (N) FLOORS, R-19 CAVITY INSULATION @BASEMENT WALLS, & R-49 INSULATION @ (N) ROOFS PER IECC.



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ELEVATIONS

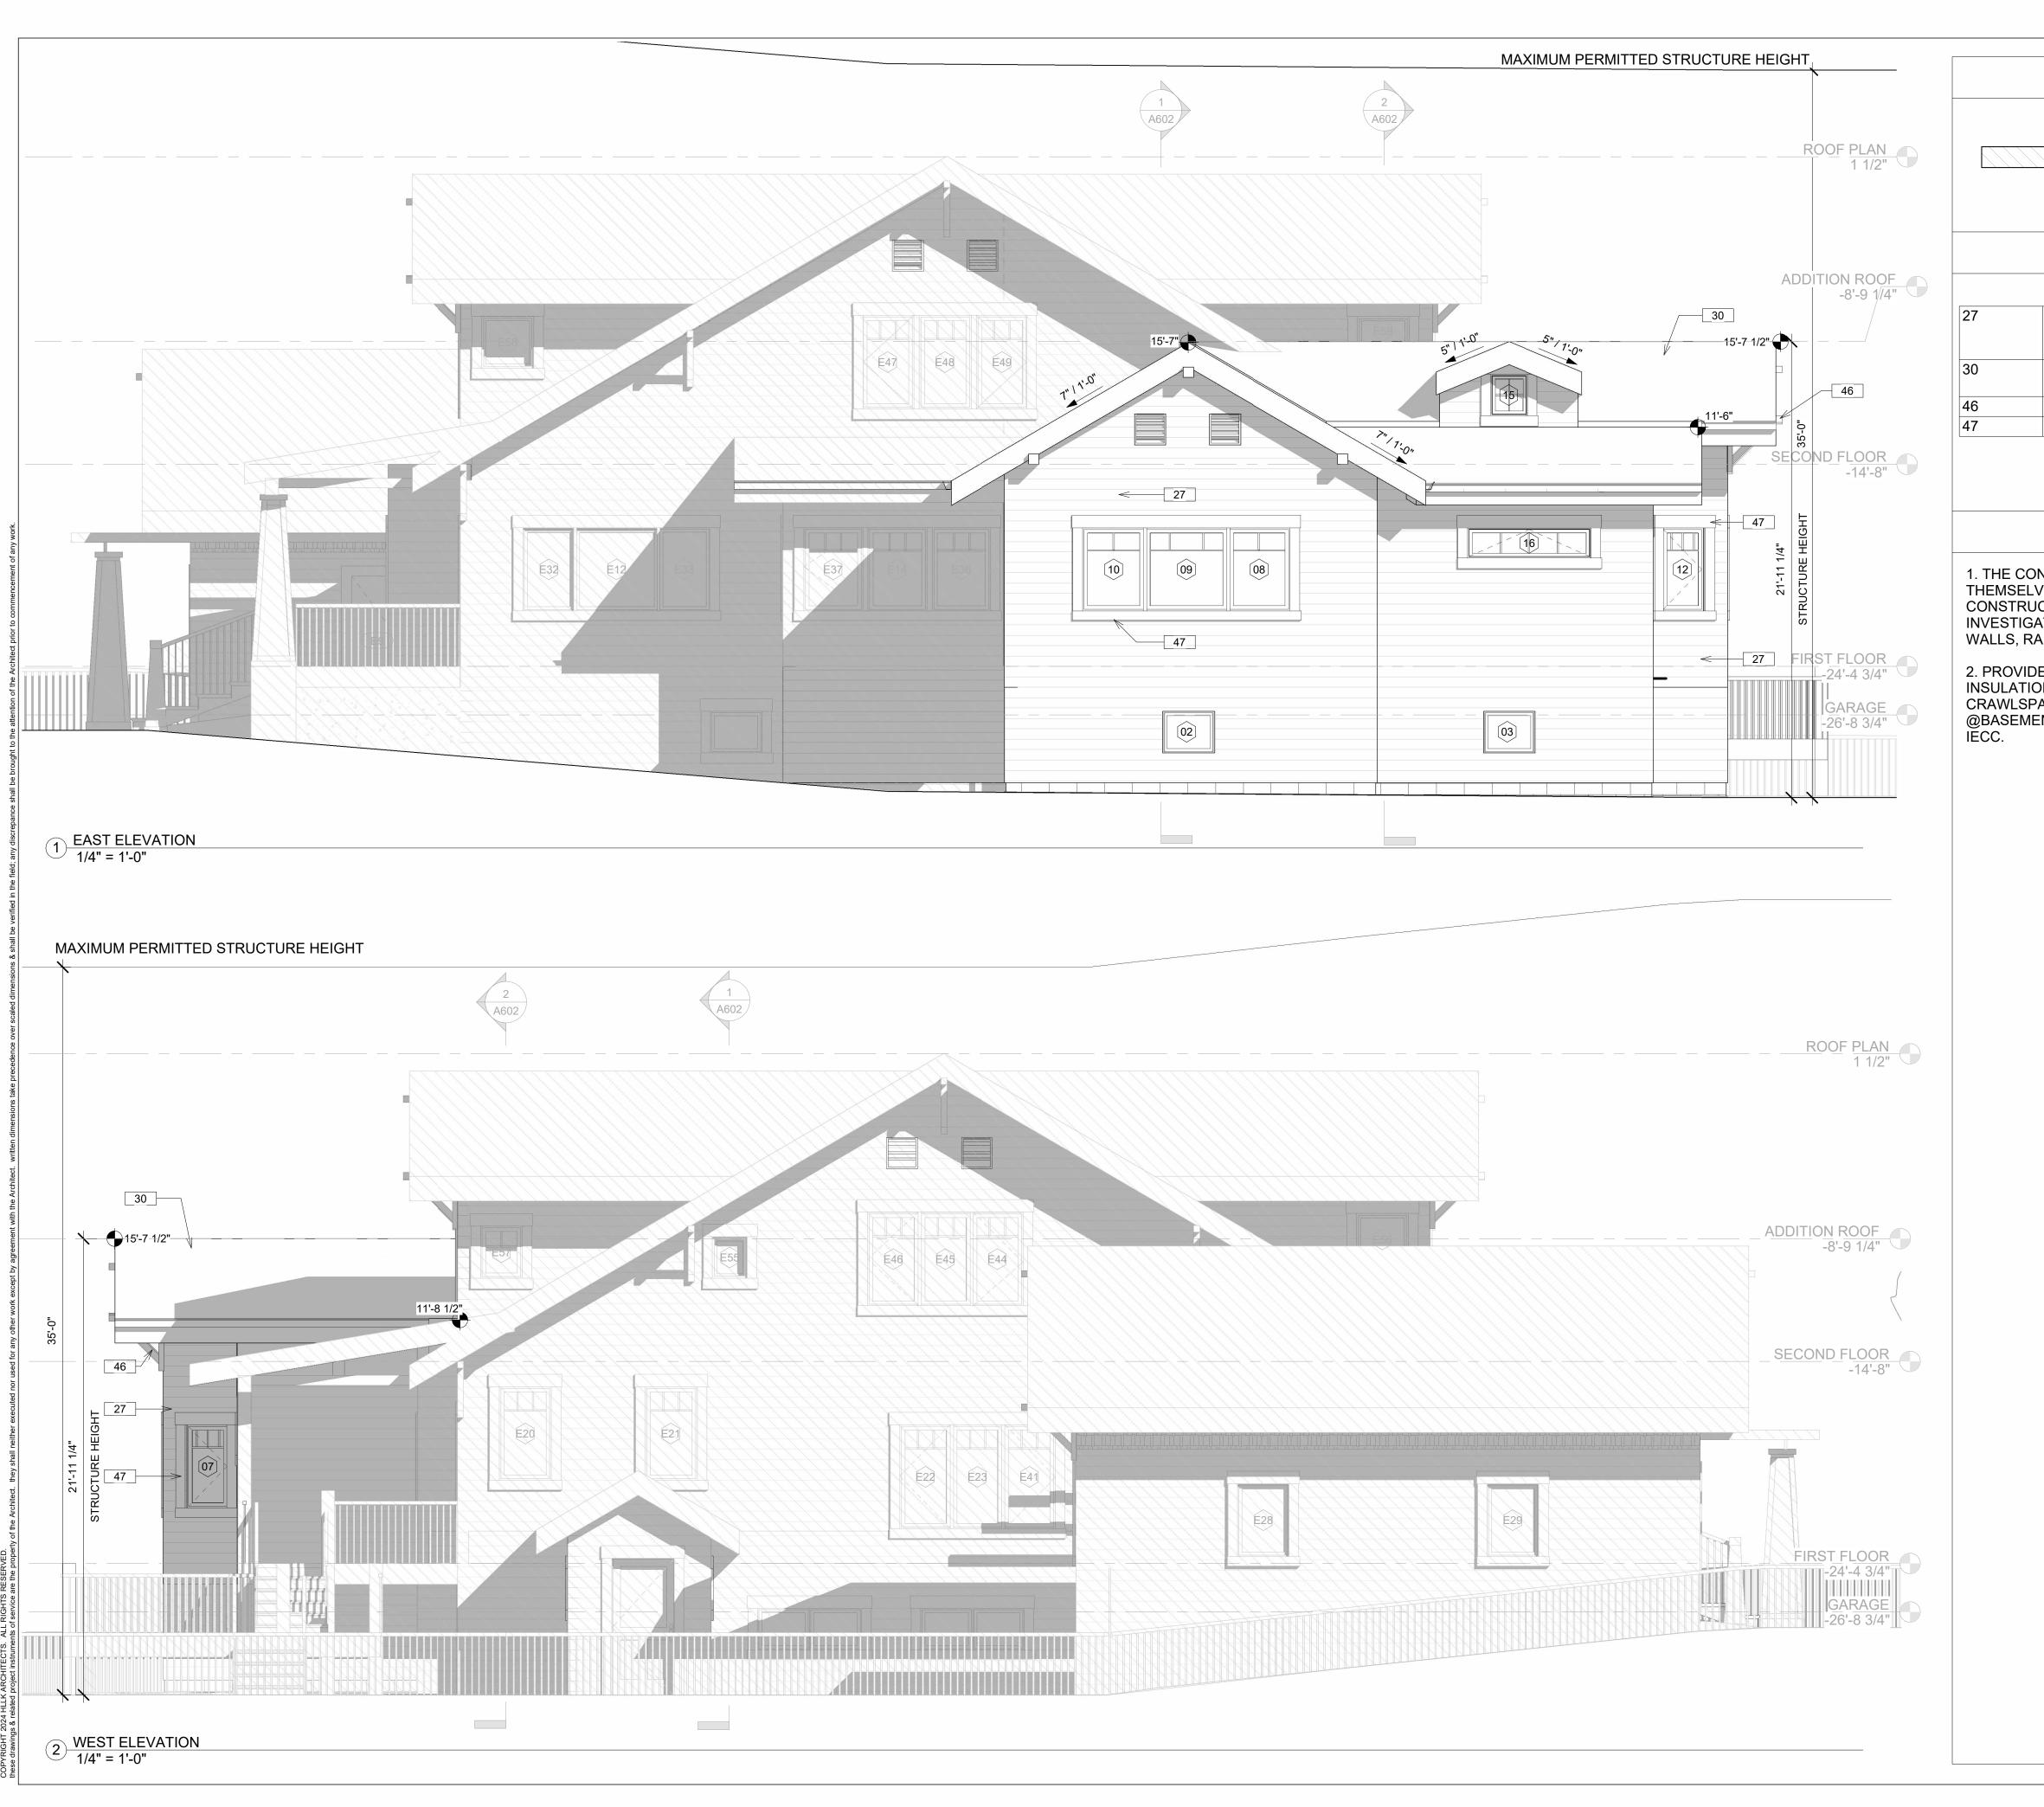
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NOT IN SCOPE

KEYNOTES

(N) HORIZONTAL SIDING 1X4 CLAPBOARD, PAINTED BY SHERWIN WILLIAMS "COOL DECEMBER CHARCOAL" TO MATCH EXISTING (N) PRESIDENTIAL COMPOSITION SHINGLES CÓLOR BLACK TO MATCH EXISTING

(N) KNEE BRACE DOUGLAS FIR, PAINTED WHITE (N) WOOD TRIM PAINTED WHITE

NOTES

1. THE CONTRACTOR SHALL VERIFY AND ACQUAINT THEMSELVES WITH THE EXISTING CONDITIONS PRIOR TO CONSTRUCTION; INCLUDING BUT NOT LIMITED TO INVESTIGATION OF EXISTING FOOTINGS, FOUNDATION WALLS, RAISED FLOORS AND SLABS.

2. PROVIDE R-20 CAVITY INSULATION PLUS R-5 CONTINUOUS INSULATION @ (N) WALLS, R-30 INSULATION @ (N) CRAWLSPACE & (N) FLOORS, R-19 CAVITY INSULATION @BASEMENT WALLS, & R-49 INSULATION @ (N) ROOFS PER IECC.



5727 La Jolla Blvd La Jolla, California, 92037 858.255.1561 lindsay@HLLKarchitects.com hilary@HLLKarchitects.com

> LICENSED ARCHITECT AR-987750 HILARY BOLARD LOWE STATE OF IDAHO

RESIDEN

	DESIGN REVIEW 02/20/2024		
No.	Description	Date	

Drawing Title:

ELEVATIONS

1/4" = 1'-0"

Sheet Number:

A601